

"G"

Project Site Plan

American Canyon Solar P18-00114-UP Planning Commission Hearing October 17, 2018

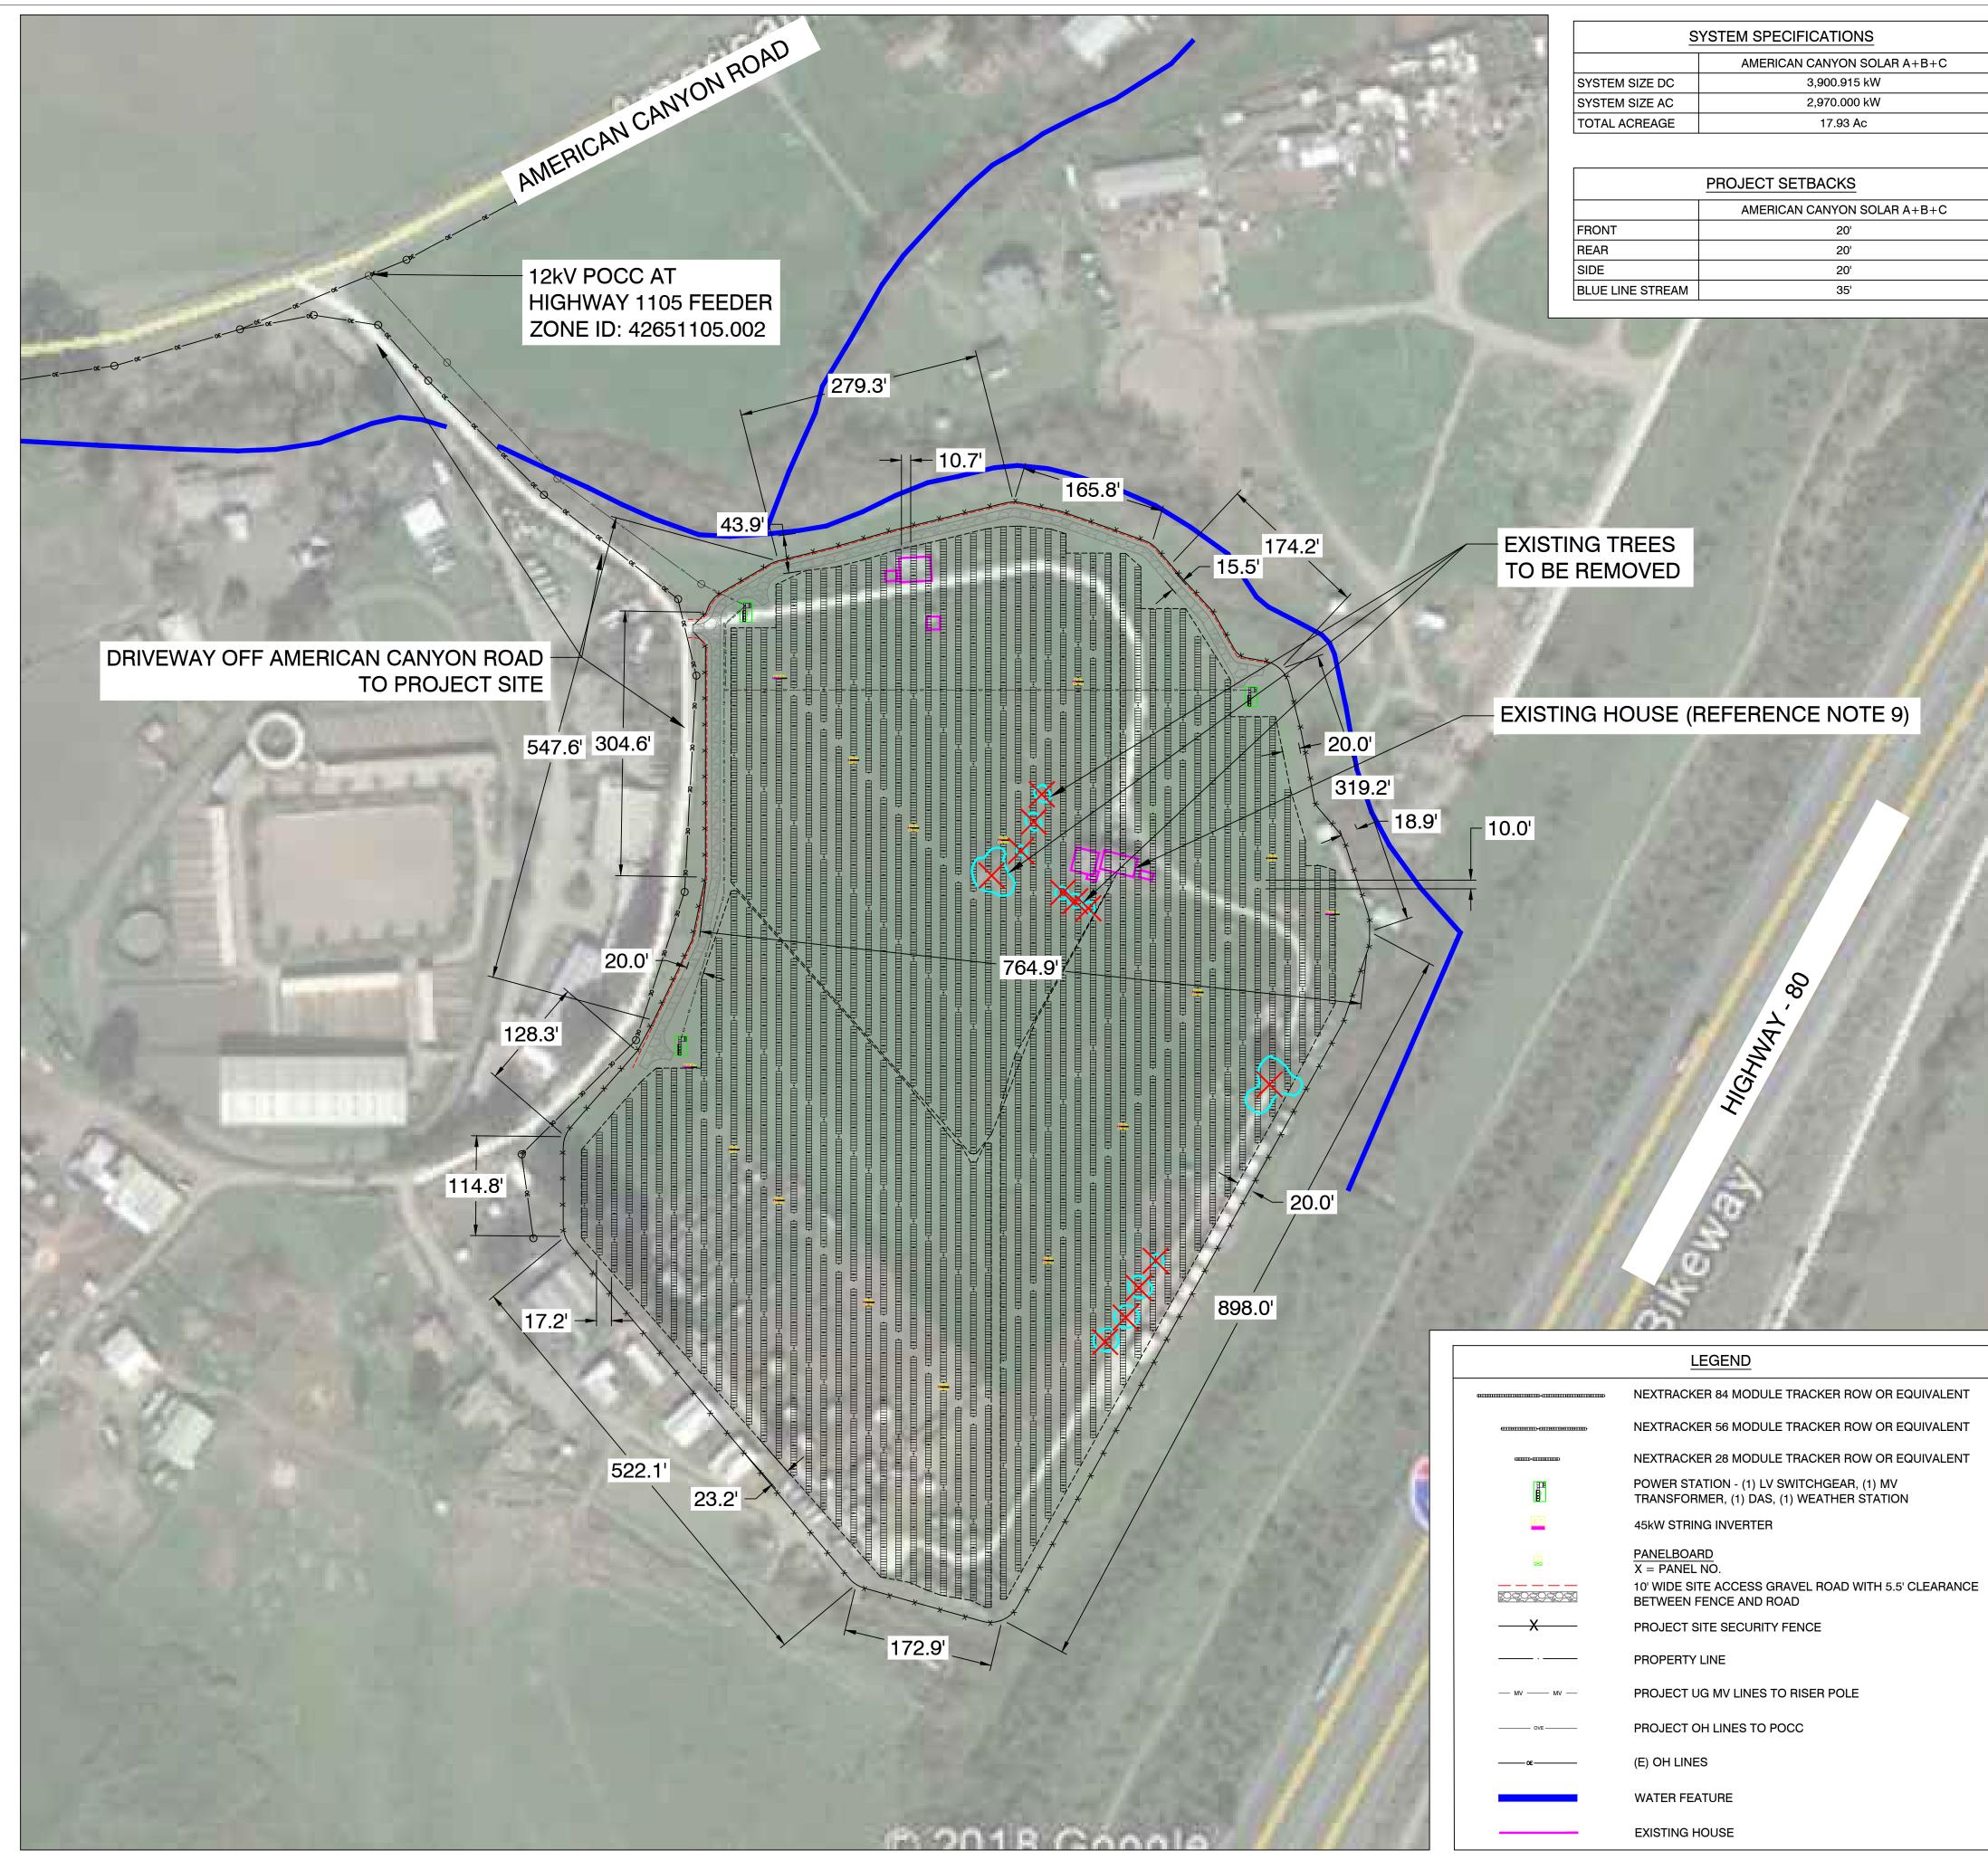

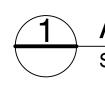

SYSTEM SPECIFICATIONS				
	AMERICAN CANYON SOLAR A+B+C			
SYSTEM SIZE DC	3,900.915 kW			
SYSTEM SIZE AC	2,970.000 kW			
TOTAL ACREAGE	17.93 Ac			

PROJECT SETBACKS			
	AMERICAN CANYON SOLAR A+B+C		
FRONT	20'		
REAR	20'		
SIDE	20'		
BLUE LINE STREAM	35'		

ARRAY PLAN SCALE:1"=100'



		AMERICAN CANYON SOLAR B	
SYSTEM SIZE DC SYSTEM SIZE AC	1304.100 kW 990.000 kW	1304.100 kW 990.000 kW	1304.100 kW 990.000 kW
DC/AC RATIO	1.32 HANWHA Q-CELLS 345W	1.32 HANWHA Q-CELLS 345W	1.32 HANWHA Q-CELLS 345W
IODULE RATING	345 W	345 W	345 W
OTAL MODULE QTY	3780 28	3780 28	3780 28
OTAL NO. OF STRINGS	135 HUAWEI SUN2000-45KTL-US	135 HUAWEI SUN2000-45KTL-US	135 HUAWEI SUN2000-45KTL-US
NVERTER RATING	45 KW	45 KW	45 KW
NVERTER QTY STEP-UP TRANSFORMER	22 12kV/600V, 990kVA	22 12kV/600V, 990kVA	22 12kV/600V, 990kVA
ACKING NTER-ROW SPACING	HSAT 10.7'	HSAT 10.7'	HSAT 10.7'
PITCH	17.2'	17.2'	17.2'
ACR	38%	38%	38%
	GENERAL	NOTES	
1. REFER TO SINGLE LI	NE DIAGRAM FOR DETAILS	S.	
2. INSTALLATION TO C	OMPLY WITH NEC 2014 AR	TICLE 690 AND ALL APPLI	CABLE LOCAL, STATE
AND NATIONAL COD	ES OR REGULATIONS.		
3. EQUIPMENT SHALL E	BE LABELED PER NEC 690	AND UTILITY REGULATIO	NS.
	SHALL BE DESIGNED TO A		
5. DIMENSIONS TO PRO SURVEY.	OPERTY LINES AND EXISTI	NG FEATURES ARE APPR	OXIMATE PENDING
	BE COMPLIANT TO THE BI	OLOGICAL CONSTRAINTS	S ANALYSIS FOR
	WATER EFFICIENT LANDSC		
	ELEVATION INFORMATION, JTCOME OF DRAINAGE CA ERFORMED).		
	RIDOR WILL BE PROVIDED E BETWEEN ROAD AND FE		F 10' GRAVEL ROAD
9. EXISTING HOUSE TO	BE REMOVED.		
	N OF THE PROPOSED 10 F		
	VARD THE PERIMETER FEN S THE FENCE. FINAL CIVIL [
		ź	
NM		CRITICAL DIMENSION. TOP OF PIER TO	CENTER OF ROTATION. VERIFY WITH PRODUCT SPECIFICATIONS.
7'-6" MIN 4'-6" MIN		CRITICAL	MAXIMUM ABOVE CENTER OF ROTATION. GRADE HEIGHT VERIFY WITH PRODUCT PER DETAIL 05 SPECIFICATIONS.
		3-3" MIN	MINIMUM EMBEDMENT MAXIMUM ABOVE CENTER OF ROTATION. 138" FOR EXTERIOR ROWS GRADE HEIGHT VERIFY WITH PRODUCT SPECIFICATIONS. 114" FOR INTERIOR ROWS PER DETAIL 05 SPECIFICATIONS.
7'-6" h			MINIMUM EMBEDMENT 138" FOR EXTERIOR ROWS 114" FOR INTERIOR ROWS
4"6"Y 1"9-Y			MINIMUM EMBEDMENT 138" FOR EXTERIOR ROWS 114" FOR INTERIOR ROWS

TYPICAL INTERNAL ACCESS ROAD CROSS SECTION (NOTE 10)



APLICATI: The problem of the proble					
ENGINEER: CALIFORNIA ENGINEERING CO. <u>owner of record:</u> JHILA ZAREBI, AS TRUSTEE OF THE BARSTOW IRREVOCABLE TRUST <u>APN:</u> 059-090-012 & 059-090-016					
AMERICAN CANYON SOLAR A, B and C					
2180 AMERICAN CANYON RD, AMERICAN CANYON, CA 94503, USA LAT: 38.160724° LON: -122.214178°					
1 REVISION PER COUNTY COMMENTS 05/29/18 0 USE PERMIT APPLICATION 03/27/18 REV. NO DESCRIPTION DATE					
SHEET TITLE: PRELIMINARY LAYOUT					
DRAWING NO.: PV-100					
DRAWN BY: LR REVIEWED BY:					
DATE:					

AS SHOWN

PROJECT NO .: