

### **NAPA COUNTY**

## PLANNING, BUILDING, AND ENVIRONMENTAL SERVICES

1195 THIRD STREET, SUITE 210, NAPA, CALIFORNIA, 94559 • (707) 253-4417

### APPLICATION FOR VIEWSHED PROTECTION PROGRAM

FOR OFFICE USE ONLY  ZONING DISTRICT: DATE SUBMITTED:
ZONING DISTRICT: DATE SUBMITTED: DATE PUBLISHED:
REQUEST:
Drainet Tyrney Structure Driveyyou Board Beconveir Man Crading Other
Project Type: Structure Driveway Road Reservoir Mass Grading Other Other Permits Applied/Pending/Required:
ECP Use Permit Variance
SDSDS Groundwater Permit:
#####
Review Agencies: PBES: _X_ County Consultant: Name/Contact:
Final Approval: PBES_X_ Date:/ Conditions: Yes No
TO BE COMPLETED BY APPLICANT
(Please type or print legibly)
Applicant's Name: NAOKO DALLA VALLE
Telephone #: (101) 944- 2616   Fax #: (67) 944- 854// E-Mail:
1471 She Til Och Ib on GUETI
Mailing Address: 7776 Street Street City State CA 94576
Status of Applicant's Interest in Property:
Property Owner's Name:
SAME AS ABOVE
Telephone #: ( Fax #: () E-Mail:
Mailing Address: 7776 Silveralo Trail Ockville CA 94576
No. Street City State Zip 1
Site Address/Location:  SAME AS ABOVE  City State Zip
Assessor's Parcel #: <u>03   - 060 - 024</u> Parcel Size: <u>26, 61</u> acres Development Area Size: <u>±0,5</u> acres
Slope Range of Development Area: <u>O</u> % to <u>IO</u> %
( <u>NOTE</u> : Contour map/survey is required for all development areas with an estimated slope of 15% or greater and for all
road/driveway projects, Contour map must include all areas within 100'of the cut and fill edges. Percent slope shall be
calculated and presented as whole numbers. (Please see attached Slope Determination Methodology)
I hereby certify that all the information contained in this application, including but not limited to, this application form, the supplemental
information sheets, site plan, plot plan, cross sections/elevations, is complete and accurate to the best of my knowledge. I hereby authorize
such investigations including access to County Assessor's Records as are deemed necessary by the County Planning Division for evaluation of this application and preparation of reports related thereto, including the right of access to the property involved.
of this application and preparation of reports related thereto, including the right of access to the property involved.
Signature of Applicant Date Signature of Property Owner Date
NAOKO DALLA VALLE NAOKO DALLA VALLE
Print Name Print Name
TO BE COMPLETED BY PLANNING, BUILDING, AND ENVIRONMENTAL SERVICES
Application Fee: \$ Receipt. No Received by: Date:
Fees billed to P14-00121

# WINERY USE PERMIT MODIFICATION Dalla Valle Vineyards 7776 Silverado Trail APN 031-060-024

#### VIEWSHED STATEMENT

The project is located on a plateau situated above the Silverado Trail on the west side of the Napa Valley. As the project consists primarily of a new building to be located adjacent to an existing winery and residence, from many locations the new construction will be effectively screened by the existing buildings. As viewed from the Oakville Crossroad, however, the existing buildings do not screen so much of the new building, and it is in this area that the new planting proposed as part of the landscape plan are most important, as they will insure that more than 50% of the new structure is screened from view.




DEC 4 2014



VIEW DIRECTION MAP: VICINITY

Not to Scale

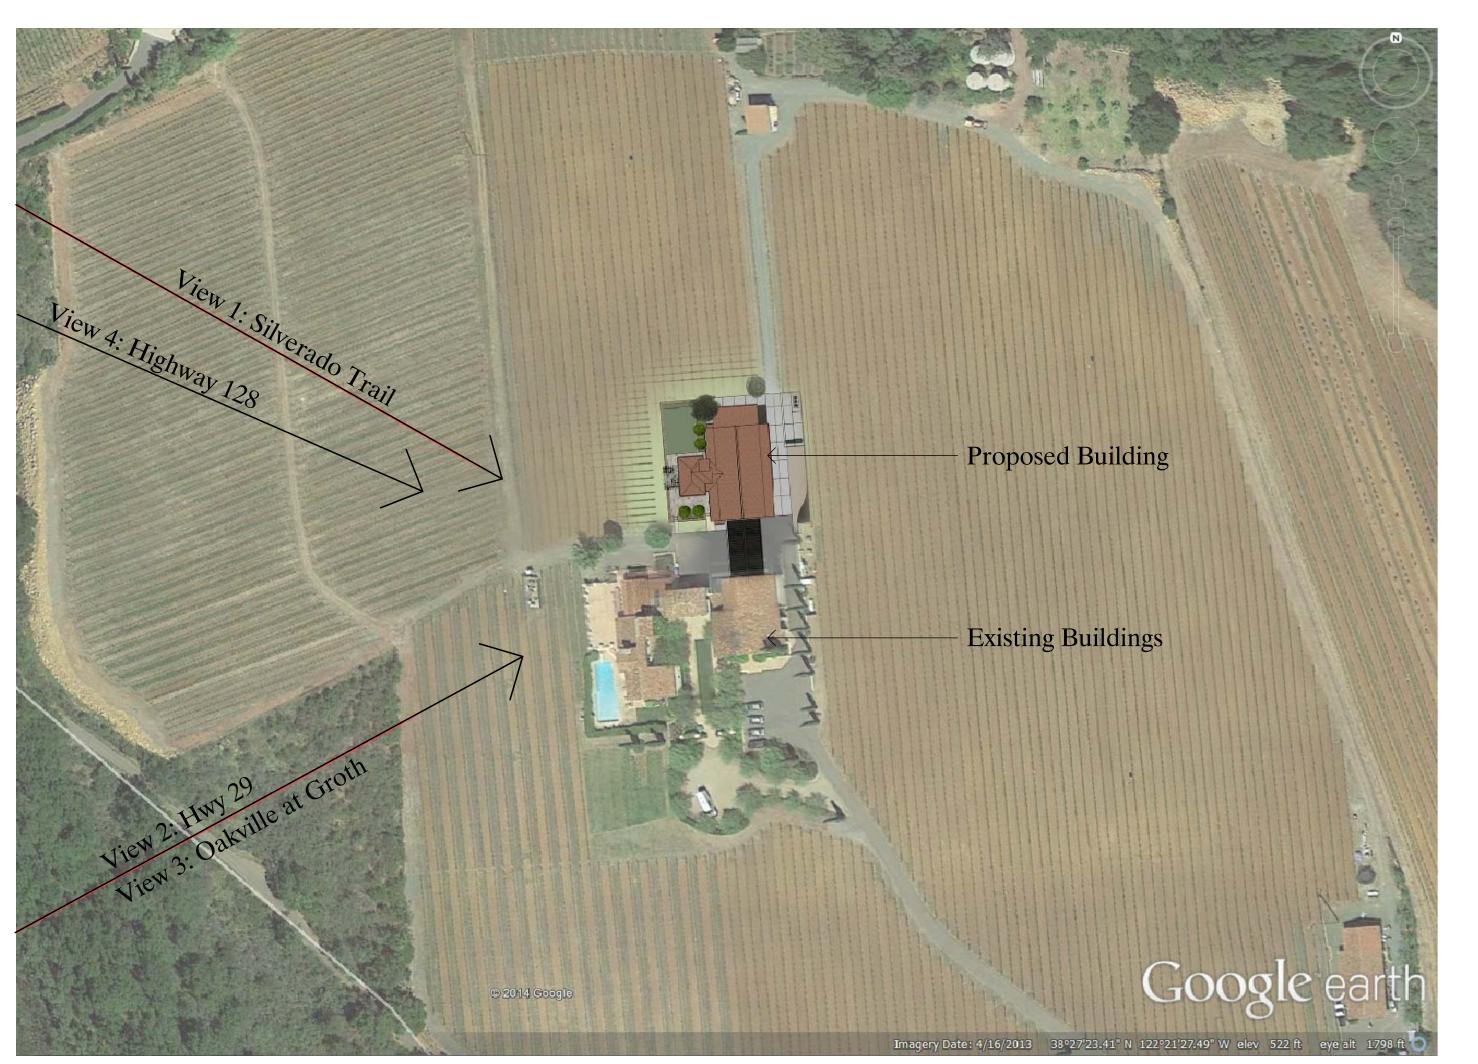

NORTH

PRELIMINARY -NOT FOR CONSTRUCTION

VIEW DIRECTION MAPS

SCALE : none

2 VIEW DIRECTION MAP: SITE

Not to Scale







Before



After

PRELIMINARY -NOT FOR CONSTRUCTION

VIEWSHED PHOTO-MONTAGES

SCALE : none



VIEW 2: FROM HIGHWAY 29





After

VIEW 3: FROM OAKVILLE AT GROTH

Before



Proposed BuildingExisting Buildings

VIEW 4: FROM HIGHWAY 128

Before

PRELIMINARY -NOT FOR CONSTRUCTION

VIEWSHED PHOTO-MONTAGES

SCALE : none

After



WEST ELEVATION

|/8"=|-0"

Dalla Valle Winery Barrel Storage Building

CHARLES COVELL
architect

PRELIMINARY -NOT FOR CONSTRUCTION

Date 05/28/202
Drawn By VNL
Checked By Project No. 1206

Date Issue 7/1/13 PRELIM SIT

WEST ELEVATION

SCALE : 1/8" = 1'

V4

### (P) Landscaped Area **NORTH** PLAN NORTH Landscape Maintenance Program: Total S.F. of Landscaped Areas: 1. Install all new plants per "firewise" guidelines, typ. (E) Elm to remain GRAPHIC SCALE 112 SQ. FT. 10\"dbh, 30' tall, 16' canopy width 2. Provide defensible space from structures for firefighters 145 SQ. FT. 40 SQ. FT access. Groundcover, planting bed, pathways or lawn are to 239 SQ. FT occupy this area. Remove any dead tress. ( IN FEET ) 22 SQ. FT 1 inch = 8 ft.(E) Elm to remain 7 SQ. FT. 3. Within 50 feet of structure remove any sick dying and 310 SQ. FT 10" dbh, 30' tall, 16' canopy width 62 SQ. FT dead trees and remove excessive dead wood and foliage. 1478 SQ. FT. 112 SQ. FT. 4. Cedrus Deodarus: Plant in late spring or early fall. 105 SQ. FT. CO) Irrigate regularly its first year. After that, watering can be 167 SQ. FT. 55 SQ. FT. reduced. Fertilize in the spring with a 3-1-2 fertilizer. Any $\infty$ = pruning desired of lower branches should be in winter. TOTAL: 2854 SQ. FT. E C (P) 10 gal. Cupressus (P) Site wall 5. Olea Europa: Plant the tree as much as 6" above grade as sempervirens (typ. of 2) (E) Residence a hedge against any subsidence that may occur over time. Ultimate height 40' (P) Pergola w/ vines — The square outline of the boxed root ball should be visible ultimate spread 6' after the tree has been planted, backfill compacted, watered in and the area graded. The planting hole should be no deeper than necessary to keep the crown of the tree (E) Elm to remain 10 6" above grade. Once the tree has been placed in the 10" dbh, 30' tall, 16' canopy width planting hole and properly orientated, the bracing and bands can be removed. Backfill, tamp and water at a slow rate to help settle and compact soil. Back fill should only consist of native soil or (P)36" box Olea Europa sand amended native soil. A light surface mulch can be (P) Flower Garden incorporated in the top 4" to 6" once back filling, water "Swan River" /(approx. ultimate spread, typ.) settling and final grade are established. Initial height 8' width 7' (P)36" box Olea Europa Ultimate height 25' "Swan River" Initial irrigations should be directed towards keeping the Ultimate width 20' Initial height 8' width 7' transplanted soil root ball moist. If the trees are to be Ultimate height 25' immediately placed on drip irrigation, make sure at least Ultimate width 20' one emitter is near the base of the trunk(s). Where possible Bunch grasses and low shrubs, typ. flood or basin irrigate transplanted trees for the first couple (E) Carport of irrigations to promote backfill settling and compaction. (P) 10 gal. Cupressus 6. Cupressus sempervirens: Dig hole shallower than the all sempervirens root ball and at least twice the width. Loosen the soil in the Ultimate height 40' planting hole. Separate the roots gently and position them ultimate spread 6'/ downward in the hole. The top of the root flare, where the roots end and the trunk begins, should be about an inch above the surrounding soil. Then make sure the tree is exactly vertical in the hole. To make it just right, use a level. Backfill, applying water to remove air pockets. Remove (P) 10 gal. Cupressus debris like stones and grass and completely break up any sempervirens (typ. of 2) Ultimate height 40' dirt clumps. Water again after the transplant is complete. (E) Elm to be removed Place mulch around each tree to a depth of 2"-3" up to but 8" dbh, 30' fall, 17' canopy width ultimate spread 6' PRELIMINARY not touching the trunk. NOT FOR (P) 10 gal. Cupressus CONSTRUCTION 7. Low shrubs, bunch grasses and flower plantings by sempervirens (typ. of 2) Ultimate height 40' owner, typ. and are not in contract. ultimate spread 6' (P) Covered Outdoor 8. Soils contaminated by construction activities, or debris (E) Winery (P) Barrel Building Production Area including but not limited to plaster, cement, paint and 05/28/2015 solvents shall be removed and replaced by general Date Drawn By Checked By contractor with fertile, clean sandy loam capable of sustainable healthy plant life. (E) Elm to be removed 8" dbh, 30' tall, 14' canopy width 9. Trees shall be staked 2-2" dia. x 8' lodgepole pine tree stakes and 2 tree ties, multi stem trees 24" and larger to be guyed with 3 wieree/turnbuckle/stake assemblies per tree. 10. Landscape contractor shall guarantee all new plantings in contract for the duration of six months. The guarantee period shall begin after the final inspection and approval. Contractor to provide a 60 day established maintenance LANDSCAPE period from that date. PLAN 11. All new 5 gallon, to 15 gallon plants to have gopher wire protection. SCALE : 1/8"=1'-0"(P) Utility Area

(E) 10" Juniperus