

“E”

Use Permit Application Packet



A Tradition of Stewardship  
A Commitment to Service

file No \_\_\_\_\_

Napa County  
Conservation, Development, and Planning Department  
1195 Third Street, Suite 210, Napa, California, 94559 phone (707) 253-4417  
web www.countyofnapa.org/cdp/ email cdp@countyofnapa.org

Use Permit Application

To be completed by Planning staff...

Application Type: \_\_\_\_\_

Date Submitted: \_\_\_\_\_ Resubmittal(s): \_\_\_\_\_ Date Complete: \_\_\_\_\_

Request: \_\_\_\_\_

\_\_\_\_\_  
\_\_\_\_\_  
\_\_\_\_\_

\*Application Fee Deposit: \$ \_\_\_\_\_ Receipt No. \_\_\_\_\_ Received by: \_\_\_\_\_ Date: \_\_\_\_\_

\*Total Fees will be based on actual time and materials

To be completed by applicant...

Project Name: Biale Vineyards Permit Modification An application for a development permit

Assessor's Parcel No: 036-190-007 Existing Parcel Size: 10.84 ac.

Site Address/Location: 4038 Big Ranch Road Napa, California 94558  
No. Street City State Zip

Primary Contact:  Owner  Applicant  Representative (attorney, engineer, consulting planner, etc.)

Property Owner: Vignerons Partners

Mailing Address: 4038 Big Ranch Road Napa, California 94558  
No. Street City State Zip

Telephone No: (707) 257 - 7555 E-Mail: bob@biale.com

Applicant (if other than property owner): Chris Dearden

Mailing Address: 4038 Big Ranch Road Napa, California 94558  
No. Street City State Zip

Telephone No: (707) 257 - 7555 E-Mail: chris@biale.com

Representative (if applicable): Land Use Planning Services

Mailing Address: 2423 Renfrew Street Napa, California 94558  
No. Street City State Zip

Telephone No: (707) 255 - 7375 E-Mail: jreddingaicp@comcast.net

RECEIVED

12/13/2016

Napa County Planning Building  
& Finance

---

## Use Permit Information Sheet

---

### Use

Narrative description of the proposed use (please attach additional sheets as necessary):

Biale Vineyards located on Big Ranch Road at Salvador Avenue is authorized to produce up to 40,000 gallons of wine annually. A 15,000+ s.f. winery was approved in May 2003 (#03088-UP). The winery was later downsized in December 2003 with as-built winery measuring approximately 10,240 s.f. not including the covered and uncovered outdoor work areas that measure approximately 9,066 s.f. Two annual marketing events for a maximum of 100 attendees were approved in 2003. Current visitation levels are 21 visitors per day on the weekdays with 45 visitors per day on the weekends. No change to the current visitation is proposed. Tasting by appointment is conducted in the first floor tasting room and on the adjacent 1160 s.f. covered porch. Winery operations have been audited as recently as 2010 and found to be in compliance with approved use permit conditions. The applicants are proposing to increase production to 60,000 gallons per year. Three existing buildings will be re-purposed to winery related uses w/no increase in footprint. The existing residence and an adjacent storage building will be converted to new tasting venues. A portion of the storage building will be converted to an employee only kitchen and staging area for marketing events. The existing barn will be re-purposed to production use for storage of shipping materials and bottle storage. Changes to the proposed marketing program are shown on page 10 of this application. A new outdoor patio and a modification to the existing circulation plan is also proposed. The site plans prepared by NMR show the locations of the buildings proposed for conversion and other changes to the existing site. Additional details are provided below.

What, if any, additional licenses or approvals will be required to allow the use?

District \_\_\_\_\_

Regional \_\_\_\_\_

State ABC

Federal TTB

### Improvements

Narrative description of the proposed on-site and off-site improvements (please attach additional sheets as necessary):

1. Re-purpose existing 2151 +/- s.f. residence to tasting room
2. Re-purpose existing 1,589 portion of 1897 +/- s.f. barn to wine and dry good storage; remainder of barn to be used for farm equipment storage (308 s.f.)
3. Re-purpose existing storage building to combined employee break room/caterers staging area (170 s.f.) and 218 s.f. tasting room
4. Construct 2589 +/- s.f. partially covered patio on east side of existing winery
5. Construct new driveway access to Big Ranch Road; remove portions of existing driveway
6. Construct improvements to each structure as required by the CBC
7. Provide new handicapped parking space
8. Install code compliant water supply, wastewater and fire suppression improvements as required
9. Portable Toilets for events of 100 or more attendees



RECEIVED  
DEC 18 2016  
Napa County Planning, Building  
& Environmental Services

December 8, 2016

Wyntress Balcher  
Planner II  
Planning, Building and Environmental Services  
1195 Third Street, Ste 210  
Napa, CA 94559

RE: P16-00396 Robert Biale Vineyards Use Permit Modification  
4038 Big Ranch Road APN 036-190-007  
Napa, California 94558

Dear Ms. Balcher,

Thank you for your application status letter of October 27, 2016. We have revised our application to address your comments and the comments made by The Engineering Division, the Fire Marshall, The Building Division and the Department of Public Works. A summary of our response to these comments is as follows:

Planning Department Comments of October 27, 2016

1. The existing residence proposed to be converted to winery use is within the 600-foot winery setback. The existing residence proposed for winery use was constructed circa 1930s prior to the time when building permits were required. Section 18.104.230(C) provides that pre-1990 structures are exempt from the 600-foot setback so long as this exemption will result in a more environmentally beneficial placement of the winery and the structure is not expanded beyond the existing footprint. Any expansion of such structure beyond the existing footprint shall comply with the 600-foot setback.

Construction of a new tasting room comparable with the existing residence would result in the additional loss of vineyard, and increase GHG emissions as a result of the harvesting and transporting of construction materials. Repurposing of the existing residence and converting it to winery use will allow for the retention of this structure, one of the original structures on the property. Its reuse provides the applicant with an economic incentive to preserve and upgrade the structure. The preservation of existing vineyard and the one of the original structures on the property is environmentally superior to the construction of a new tasting room.

No expansion of the footprint of the existing residence is proposed. The proposed tasting room is required to provide a new accessible walkway and ramp.

555 Main St., Suite 300  
Chico, CA 95928

NICHOLS • MELBURG & ROSSETTO  
ARCHITECTS/ENGINEERS  
Redding Chico Santa Rosa

Phone (530) 891-1710  
Fax (530) 891-0138  
[gonsalves@nrmrdesign.com](mailto:gonsalves@nrmrdesign.com)



2. The second page of the Water Availability Analysis – Phase One is not included with the application. Page two of the Water Availability Analysis – Phase One is included in our revised application. Our analysis indicates a slight decrease in water use as a result of converting the existing residence to winery use and the loss of vineyard resulting from construction of the new driveway. We anticipate additional water savings will occur due to decreased vineyard irrigation as additional conservation measures not associated with this use permit modification are implemented.
3. There is no overall site plan that clearly identifies all the structures that will comprise the winery development area. A “Proposed Winery Development Site Plan” was added to sheet A010. This plan clearly shows the existing winery building and the three existing buildings (existing Residence, existing Barn and existing Storage Building) proposed for conversion to winery use.
4. Please note that Use Permit No. 03088-UP was permitted for tours and tastings by appointment only with a maximum of four visitors per day (not including marketing) an average of ten per week with four full-time and three part-time employees. The traffic characteristics evaluated 16 total average daily trips and 22 peak day trips.
5. Please provide the hours that the events will be scheduled and please indicate if the winery tasting room will be open on these days and during these events. Marketing events conducted on weekdays will be scheduled to avoid guests either arriving or departing during either morning or afternoon peak hour periods. No appointments will be scheduled for tours or tastings during larger marketing events; i.e., those with 100 or more attendees.

Engineering and Conservation Division Comments of October 11, 2016 regarding Stormwater

1. Please show all storm drain pipes, storm water dissipaters and retention areas on the plan set. All existing and proposed storm drain pipes, storm water dissipaters and retention areas have been added to three new civil plan sheets (C200, C210 and C220) that make up the exhibits for our Stormwater Control Plan.
2. Please note the proposed overflow parking area and decomposed granite courtyard area are seen as an impervious surface as defined in the Phase II MS4 General Permit or as defined in Section 4-6 of the BASMAA manual titled – “Design Guidance for Stormwater Treatment and Control for Projects in Marin, Sonoma, Napa and Solano Counties.” We have revised the pervious and impervious surface calculations in our revised application and in the “Existing and Proposed Winery Coverage” table on sheet A010 to include the proposed decomposed granite path on the south side of the overflow parking area, the proposed concrete sidewalk just north of the existing visitor parking spaces and the decomposed granite area of the proposed expanded



outdoor hospitality area as impervious surfaces. We clarified the construction of the overflow parking area itself to be a geogrid grass paver system (see revised Sheet Note number five) which is classified as a pervious pavement by the BASMAA manual Section 4-6 and Table 4.1.

3. Please provide a Stormwater Control Plan (SCP) prepared for your project in accordance with the BASMAA manual titled – “Design Guidance for Stormwater Treatment and Control for Projects in Marin, Sonoma, Napa and Solano Counties.” We have produced a Stormwater Control Plan showing the existing drainage systems are generally in conformance with the BASMAA manual. The SCP is included with our resubmitted application.

#### Napa County Fire Marshall Comments of December 6, 2016

The Fire Marshall approves as submitted and requires the six conditions contained in the letter to be incorporated as part of entitlement issuance: We accept the six conditions proposed by the Fire Marshal. The existing winery building is protected by a system approved April 22, 2005 under permit number B04-1704 as required by condition number three. The system consists of a fire pump and controller housed in a separate dedicated building, three 10,500-gallon above-ground fire water storage tanks, underground fire mains with thrust blocks, two hydrants (locations shown on revised plan set; southeast corner of crush pad and near existing visitor parking), a post-indicator valve (PIV) and fire department connection (FDC). The existing winery building is sprinklered. It appears that, relative to the existing winery building, all six of the conditions are met. It also appears that conditions five and six are met for all three other existing buildings proposed to be converted to winery use.

#### Napa County Public Work's comments of October 21, 2016

1. A traffic impact study is not needed.
2. A left-turn lane on Big Ranch Road is not required.
3. An encroachment permit will be required prior to construction of the proposed new driveway. After approval of P16-00396 Robert Biale Vineyards Use Permit Modification we will submit an encroachment permit application for construction of the proposed new driveway.

#### Napa County Building Inspection Division comments of October 14, 2016

1. The Building Division has no issues or concerns with the approval of Use Permit P16-00396 as it is a planning entitlement and does not in itself authorize any construction activities. Separate Building permits shall be required. After approval of P16-00396

555 Main St., Suite 300  
Chico, CA 95928

NICHOLS • MELBURG & ROSSETTO  
ARCHITECTS/ENGINEERS  
Redding Chico Santa Rosa

Phone (530) 891-1710  
Fax (530) 891-0138  
[gonsalves@nrmrdesign.com](mailto:gonsalves@nrmrdesign.com)



Robert Biale Vineyards Use Permit Modification we will submit plans and calculations necessary and obtain a building permit(s) for the proposed modifications to the existing Residence (making it comply with CBC Chapter 11-B for disable access), for the proposed modifications to the existing Storage Building and for the expansion of the outdoor hospitality area east of the existing tasting room.

All resubmitted plans, and new plan sheets which are exhibits for the Stormwater Control Plan, are shown as being "Revision 1" in the revisions section of the title block (lower right hand corner of the sheet). The date of drawings which were revised has been changed to December 1, 2016. Sheets that are resubmitted but not revised (A300 series) have the "Revision 1" information in the revision section but still have the original August 25, 2016 date. If you have any questions or concerns or require additional information, please contact me.

Best regards,

Stephen A. Gonsalves  
Principal Architect & Structural Engineer  
Nichols Melburg & Rossetto

555 Main St., Suite 300  
Chico, CA 95928

NICHOLS • MELBURG & ROSSETTO  
ARCHITECTS/ENGINEERS  
Redding Chico Santa Rosa

Phone (530) 891-1710  
Fax (530) 891-0138  
[gonsalves@nrmrdesign.com](mailto:gonsalves@nrmrdesign.com)

**From:** [Jeffrey Redding](#)  
**To:** [Balcher, Wyntress](#)  
**Subject:** Biale Vineyards AB 2004 On Site Wine Consumption  
**Date:** Thursday, May 11, 2017 11:10:48 AM

---

Wyntress, thanks for the follow up. Speaking with my clients, here is a listing of the areas that would like authorization for the AB 2004 areas:

1. Existing Tasting Room and adjacent Porch area (north side of the existing winery building);
2. New/proposed landscaped area on east side of existing tasting room
3. Tractor/Chicken Shed (when remodeled) on North side of building
4. Lawn area under sycamores in front of Tractor/Chicken Shed (used primarily for events)
5. Former Rental House interior, front porch, flagstone patio at entry and back lawn area

Please let us know if you have any issues with these.

Thanks again; see you on the 7th (if not before).

Jeff



**Improvements, cont.**

Total on-site parking spaces: 25 existing 26 proposed  
Loading areas: 1 existing 1 proposed

Fire Resistivity (check one; if not checked, Fire Marshal will assume Type V – non rated):

Type I FR     Type II 1 Hr     Type II N (non-rated)     Type III 1 Hr     Type III N  
 Type IV H.T. (Heavy Timber)     Type V 1 Hr.     Type V (non-rated)  
*(for reference, please see the latest version of the California Building Code)*

Is the project located in an Urban/Wildland Interface area?     Yes     No

Total land area to be disturbed by project (include structures, roads, septic areas, landscaping, etc): 0.33 acres

**Employment and Hours of Operation**

Days of operation: Tuesday-Saturday existing    Sunday-Saturday proposed  
Hours of operation: 8:00 am-4:30 pm existing    8:00 am-4:30 pm proposed  
Anticipated number of employee shifts: 1 existing    1 proposed  
Anticipated shift hours: 8:00 am-4:30 pm existing    8:00 am-4:30 pm proposed

Maximum Number of on-site employees:

10 or fewer     11-24     25 or greater (specify number) \_\_\_\_\_

Alternately, you may identify a specific number of on-site employees:

other (specify number) 12 FT/6 PT

RECEIVED  
DEC 13 2016  
Napa County Planning, Building  
& Environmental Services

---

## Certification and Indemnification

---

Applicant certifies that all the information contained in this application, including all information required in the Checklist of Required Application Materials and any supplemental submitted information including, but not limited to, the information sheet, water supply/waste disposal information sheet, site plan, floor plan, building elevations, water supply/waste disposal system site plan and toxic materials list, is complete and accurate to the best of his/her knowledge. Applicant and property owner hereby authorize such investigations including access to County Assessor's Records as are deemed necessary by the County Planning Division for preparation of reports related to this application, *including the right of access to the property involved.*

Pursuant to Chapter 1.30 of the Napa County Code, as part of the application for a discretionary land use project approval for the project identified below, Applicant agrees to defend, indemnify, release and hold harmless Napa County, its agents, officers, attorneys, employees, departments, boards and commissions (hereafter collectively "County") from any claim, action or proceeding (hereafter collectively "proceeding") brought against County, the purpose of which is to attack, set aside, void or annul the discretionary project approval of the County, or an action relating to this project required by any such proceeding to be taken to comply with the California Environmental Quality Act by County, or both. This indemnification shall include, but not be limited to damages awarded against the County, if any, and cost of suit, attorneys' fees, and other liabilities and expenses incurred in connection with such proceeding that relate to this discretionary approval or an action related to this project taken to comply with CEQA whether incurred by the Applicant, the County, and/or the parties initiating or bringing such proceeding. Applicant further agrees to indemnify the County for all of County's costs, attorneys' fees, and damages, which the County incurs in enforcing this indemnification agreement.

Applicant further agrees, as a condition of project approval, to defend, indemnify and hold harmless the County for all costs incurred in additional investigation of or study of, or for supplementing, redrafting, revising, or amending any document (such as an EIR, negative declaration, specific plan, or general plan amendment) if made necessary by said proceeding and if the Applicant desires to pursue securing approvals which are conditioned on the approval of such documents.

In the event any such proceeding is brought, County shall promptly notify the Applicant of the proceeding, and County shall cooperate fully in the defense. If County fails to promptly notify the Applicant of the proceeding, or if County fails to cooperate fully in the defense, the Applicant shall not thereafter be responsible to defend, indemnify, or hold harmless the County. The County shall retain the right to participate in the defense of the proceeding if it bears its own attorneys' fees and costs, and defends the action in good faith. The Applicant shall not be required to pay or perform any settlement unless the settlement is approved by the Applicant.

Robert Biate

Print Name of Property Owner

Print Name Signature of Applicant (if different)

*Robert Biate* 9/8/16

*[Signature]* 9/8/16

Signature of Property Owner

Date

Signature of Applicant

Date

## Supplemental Application for Winery Uses

### Operations

Please indicate whether the activity or uses below are already legally **EXISTING**, whether they exist and are proposed to be **EXPANDED** as part of this application, whether they are **NEWLY PROPOSED** as part of this application, or whether they are neither existing nor proposed (**NONE**).

Retail Wine Sales	<input checked="" type="checkbox"/> Existing	<input type="checkbox"/> Expanded	<input type="checkbox"/> Newly Proposed	<input type="checkbox"/> None
Tours and Tasting- Open to the Public	<input type="checkbox"/> Existing			
Tours and Tasting- By Appointment	<input checked="" type="checkbox"/> Existing	<input type="checkbox"/> Expanded	<input type="checkbox"/> Newly Proposed	<input type="checkbox"/> None
Food at Tours and Tastings	<input type="checkbox"/> Existing	<input type="checkbox"/> Expanded	<input type="checkbox"/> Newly Proposed	<input type="checkbox"/> None
Marketing Events*	<input checked="" type="checkbox"/> Existing	<input type="checkbox"/> Expanded	<input type="checkbox"/> Newly Proposed	<input type="checkbox"/> None
Food at Marketing Events	<input checked="" type="checkbox"/> Existing	<input type="checkbox"/> Expanded	<input type="checkbox"/> Newly Proposed	<input type="checkbox"/> None
Will food be prepared...		<input type="checkbox"/> On-Site?	<input checked="" type="checkbox"/> Catered?	
Public display of art or wine-related items	<input type="checkbox"/> Existing	<input type="checkbox"/> Expanded	<input type="checkbox"/> Newly Proposed	<input checked="" type="checkbox"/> None

\* For reference please see definition of "Marketing," at Napa County Code §18.08.370 - <http://library.municode.com/index.aspx?clientId=16513>

### Production Capacity \*

Please identify the winery's...

Existing production capacity: 40,000 gal/y Per permit No: 03088-UP Permit date: 5/23/03

Current maximum actual production: 36,689 gal/y For what year? 2015

Proposed production capacity: 60,000 gal/y

\* For this section, please see "Winery Production Process," at page 11.

RECEIVED

DEC 13 2016

Napa County Planning, Building  
& Environmental Services

### Visitation and Hours of Operation

Please identify the winery's...

Maximum daily tours and tastings visitation:	<u>60 (WE)/30 (WD)</u> existing	<u>60 (WE)/30 (WD)</u> proposed
Average daily tours and tastings visitation <sup>1</sup> :	<u>30 (WE)/15 (WD)</u> existing	<u>30 (WE)/15(WD)</u> proposed
Visitation hours (e.g. M-Sa, 10am-4pm):	<u>Tu-Sat, 10am-4pm</u> existing	<u>Sun-Sat, 10am-4pm</u> proposed
Non-harvest Production hours <sup>2</sup> :	<u>6:00 am-3:00 pm</u> existing	<u>6:00 am-3:00 pm</u> proposed

<sup>1</sup> Average daily visitation is requested primarily for purposes of environmental review and will not, as a general rule, provide a basis for any condition of approval limiting allowed winery visitation.

<sup>2</sup> It is assumed that wineries will operate up to 24 hours per day during crush.

## Grape Origin

All new wineries and any existing (pre-WDO) winery expanding beyond its winery development area must comply with the 75% rule and complete the attached "Initial Statement of Grape Source". See Napa County Code §18.104.250 (B) & (C).

## Marketing Program

Please describe the winery's proposed marketing program. Include event type, maximum attendance, food service details, etc. Differentiate between existing and proposed activities. (Attach additional sheets as necessary.)

### Approved Marketing Plan

2/year for 100 persons (maximum)

Participation in Napa Valley Wine Auction, Premier Napa Valley (100 persons maximum)

### Additional Marketing Events Proposed

2/year for 15 persons (maximum)

2/month for 25 persons (maximum)

4/year for 50 persons (maximum)

2/year for 250 persons (maximum)

Portable Toilets will be used for events for 100 or more attendees

## Food Service

Please describe the nature of any proposed food service including type of food, frequency of service, whether prepared on site or not, kitchen equipment, eating facilities, etc. Please differentiate between existing and proposed food service. (Attach additional sheets as necessary.)

On-site kitchen for employee and for use as staging area for caterer use

RECEIVED

DEC 13 2016

Napa County Planning, Building  
& Environmental Services

---

Initial Statement of Grape Source

---

Pursuant to Napa County Zoning Ordinance Sections 12419(b) and (c),  
I hereby certify that the current application for establishment or expansion of a winery  
pursuant to the Napa County Winery Definition Ordinance will employ sources of  
grapes in accordance with the requirements of Section 12419(b) and/or (c) of that  
Ordinance.

  
Owner's Signature

  
Date

*Letters of commitment from grape suppliers and supporting documents may be required prior to issuance of any building permits for the project. Recertification of compliance will be required on a periodic basis. Recertification after initiation of the requested wine production may require the submittal of additional information regarding individual grape sources. Proprietary information will not be disclosed to the public.*

## Winery Coverage and Accessory/Production Ratio

**Winery Development Area.** Consistent with the definition at "a.," at page 11 and with the marked-up site plans included in your submittal, please indicate your proposed winery development area. If the facility already exists, please differentiate between existing and proposed.

Existing	<u>24,355</u> sq. ft.	<u>0.56</u> acres
Proposed	<u>29,131</u> sq. ft.	<u>0.67</u> acres

**Winery Coverage.** Consistent with the definition at "b.," at page 11 and with the marked-up site plans included in your submittal, please indicate your proposed winery coverage (maximum 25% of parcel or 15 acres, whichever is less).

<u>61,840</u> sq. ft.	<u>1.42</u> acres	<u>13.1</u> % of parcel
-----------------------	-------------------	-------------------------

**Production Facility.** Consistent with the definition at "c.," at page 11 and the marked-up floor plans included in your submittal, please indicate your proposed *production* square footage. If the facility already exists, please differentiate between existing and proposed.

Existing	<u>16,701</u> sq. ft.	Proposed	<u>18,727</u> sq. ft.
----------	-----------------------	----------	-----------------------

**Accessory Use.** Consistent with the definition at "d.," at page 11 and the marked-up floor plans included in your submittal, please indicate your proposed *accessory* square footage. If the facility already exists, please differentiate between existing and proposed. (maximum = 40% of the production facility)

Existing	<u>2,752 (2003-3,339 s.f.)</u> sq. ft.	<u>16.48</u> % of production facility
Proposed	<u>5,502</u> sq. ft.	<u>29.38</u> % of production facility

## Caves and Crushpads

If new or expanded caves are proposed please indicate which of the following best describes the public accessibility of the cave space:

- None – no visitors/tours/events (Class I)
  Guided Tours Only (Class II)
  Public Access (Class III)
  Marketing Events and/or Temporary Events (Class III)

Please identify the winery's...

Cave area	Existing: <u>None</u> sq. ft.	Proposed: <u>None</u> sq. ft.
Covered crush pad area	Existing: <u>6,492</u> sq. ft.	Proposed: <u>6,492</u> sq. ft.
Uncovered crush pad area	Existing: <u>2,787</u> sq. ft.	Proposed: <u>2,787</u> sq. ft.

**RECEIVED**  
 DEC 13 2016  
 Napa County Planning, Building  
 & Environmental Services

# Water Supply/ Waste Disposal Information Sheet

## Water Supply

Please attach completed Phase I Analysis sheet.

	Domestic	Emergency
Proposed source of water (e.g., spring, well, mutual water company, city, district, etc.):	<u>Existing Well</u>	_____
Name of proposed water supplier (if water company, city, district):	<u>N/A</u>	_____
Is annexation needed?	<input type="checkbox"/> Yes <input checked="" type="checkbox"/> No	<input type="checkbox"/> Yes <input checked="" type="checkbox"/> No
Current water use:	<u>5500</u> gallons per day (gal/d)	
Current water source:	<u>Existing Well</u>	_____
Anticipated future water demand:	<u>5750</u> gal/d	_____ gal/d
Water availability (in gallons/minute):	<u>75</u> gal/m	_____ gal/m
Capacity of water storage system:	<u>10,000</u> gal	<u>30,000</u> gal
Type of emergency water storage facility if applicable (e.g., tank, reservoir, swimming pool, etc.):	<u>50,000 Gal. Tank</u>	

## Liquid Waste

Please attach Septic Feasibility Report

	Domestic	Other
Type of waste:	<u>sewage</u>	<u>Winery/Process</u>
Disposal method (e.g., on-site septic system, on-site ponds, community system, district, etc.):	<u>On-Site</u>	<u>On-Site</u>
Name of disposal agency (if sewage district, city, community system):	<u>N/A</u>	<u>N/A</u>
Is annexation needed?	<input type="checkbox"/> Yes <input checked="" type="checkbox"/> No	<input type="checkbox"/> Yes <input checked="" type="checkbox"/> No
Current waste flows (peak flow):	<u>337</u> gal/d	<u>1239</u> gal/d
Anticipated future waste flows (peak flow):	<u>337</u> gal/d	<u>1490</u> gal/d
Future waste disposal design capacity:	_____ gal/d	_____ gal/d

## Solid Waste and Recycling Storage and Disposal

Please include location and size of solid waste and recycling storage area on site plans in accordance with the guidelines available at [www.countyofnapa.org/dem](http://www.countyofnapa.org/dem).

## Hazardous and/or Toxic Materials

If your facility generates hazardous waste or stores hazardous materials above threshold planning quantities (55 gallons liquid, 500 pounds solid or 200 cubic feet of compressed gas) then a hazardous materials business plan and/or a hazardous waste generator permit will be required.

## Grading Spoils Disposal

Where will grading spoils be disposed of?  
(e.g. on-site, landfill, etc. If off-site, please indicate where off-site): \_\_\_\_\_

RECEIVED  
 10/18/15  
 Napa County Planning Building  
 & Environmental Services

## Winery Traffic Information / Trip Generation Sheet

### Traffic during a Typical Weekday

Number of FT employees: <u>10.15</u> x 3.05 one-way trips per employee	=	<u>30.96</u> daily trips.
Number of PT employees: <u>3.00</u> x 1.90 one-way trips per employee	=	<u>5.70</u> daily trips.
Average number of weekday visitors: <u>21.2</u> / 2.6 visitors per vehicle x 2 one-way trips	=	<u>16.31</u> daily trips.
Gallons of production: <u>60,000</u> / 1,000 x .009 truck trips daily <sup>3</sup> x 2 one-way trips	=	<u>1.08</u> daily trips.
<b>Total</b>	<b>=</b>	<b><u>54.20</u> daily trips.</b>
(No of FT employees) + (No of PT employees/2) + (sum of visitor and truck trips x .38)	=	<u>18.26</u> <b>PM peak trips.</b>

### Traffic during a Typical Saturday

Number of FT employees (on Saturdays): <u>1.50</u> x 3.05 one-way trips per employee	=	<u>4.58</u> daily trips.
Number of PT employees (on Saturdays): <u>3.00</u> x 1.90 one-way trips per employee	=	<u>5.70</u> daily trips.
Average number of Saturday visitors: <u>45.4</u> / 2. 8 visitors per vehicle x 2 one-way trips	=	<u>34.91</u> daily trips.
<b>Total</b>	<b>=</b>	<b><u>45.19</u> daily trips.</b>
(No of FT employees) + (No of PT employees/2) + (visitor trips x .57)	=	<u>22.90</u> <b>PM peak trips.</b>

### Traffic during a Crush Saturday

Number of FT employees (during crush): <u>1.50</u> x 3.05 one-way trips per employee	=	<u>4.58</u> daily trips.
Number of PT employees (during crush): <u>3.00</u> x 1.90 one-way trips per employee	=	<u>5.70</u> daily trips.
Average number of Saturday visitors: <u>53.6</u> / 2. 8 visitors per vehicle x 2 one-way trips	=	<u>38.29</u> daily trips.
Gallons of production: <u>60,000</u> / 1,000 x .009 truck trips daily x 2 one-way trips	=	<u>1.08</u> daily trips.
Avg. annual tons of grape on-haul: <u>363.64</u> / 144 truck trips daily <sup>4</sup> x 2 one-way trips	=	<u>5.05</u> daily trips.
<b>Total</b>	<b>=</b>	<b><u>54.70</u> daily trips.</b>

### Largest Marketing Event- Additional Traffic

Number of event staff (largest event): <u>3</u> x 2 one-way trips per staff person	=	<u>6.00</u> trips.
Number of visitors (largest event): <u>250</u> / 2.8 visitors per vehicle x 2 one-way trips	=	<u>178.57</u> trips.
Number of special event truck trips (largest event): <u>2</u> x 2 one-way trips	=	<u>4.00</u> trips.

RECEIVED

DEC 18 2015

Wine Marketing, Sales & Environmental Services

<sup>3</sup> Assumes 1.47 materials & supplies trips + 0.8 case goods trips per 1,000 gallons of production / 250 days per year (see *Traffic Information Sheet Addendum* for reference).

<sup>4</sup> Assumes 4 tons per trip / 36 crush days per year (see *Traffic Information Sheet Addendum* for reference).





A Tradition of Stewardship  
A Commitment to Service

**Department of Public Works**

1195 Third Street, Suite 201  
Napa, CA 94559-3092  
www.co.napa.ca.us/publicworks

Main: (707) 253-4351  
Fax: (707) 253-4627

**Donald G. Ridenhour, P.E.**  
Director

**WATER AVAILABILITY ANALYSIS - PHASE ONE STUDY**

**Introduction:** As an applicant for a permit with Napa County, It has been determined that Chapter 13.15 of the Napa County Code is applicable to approval of your permit. One step of the permit process is to adequately evaluate the amount of water your project will use and the potential impact your application might have on the static groundwater levels within your neighborhood. The public works department requires that a Phase 1 Water Availability Analysis (WAA) be included with your application. The purpose of this form is to assist you in the preparation of this analysis. You may present the analysis in an alternative form so long as it substantially includes the information required below. Please include any calculations you may have to support your estimates.

The reason for the WAA is for you, the applicant, to inform us, to the best of your ability, what changes in water use will occur on your property as a result of an approval of your permit application. By examining the attached guidelines and filling in the blanks, you will provide the information we require to evaluate potential impacts to static water levels of neighboring wells.

**Step #1:** ← Attached at back of application

Provide a map and site plan of your parcel(s). The map should be an 8-1/2"x11" reproduction of a USGS quad sheet (1:24,000 scale) with your parcel outlined on the map. Include on the map the nearest neighboring well. The site plan should be an 8-1/2"x11" site plan of your parcel(s) with the locations of all structures, gardens, vineyards, etc in which well water will be used. If more than one water source is available, indicate the interconnecting piping from the subject well to the areas of use. Attach these two sheets to your application. If multiple parcels are involved, clearly show the parcels from which the fair share calculation will be based and properly identify the assessor's parcel numbers for these parcels. Identify all existing or proposed wells

**Step #2: Determine total parcel acreage and water allotment factor. If your project spans multiple parcels, please fill a separate form for each parcel.**

Determine the allowable water allotment for your parcels:

**Parcel Location Factors**

The allowable allotment of water is based on the location of your parcel. There are 3 different location classifications. Valley floor areas include all locations that are within the Napa Valley, Pope Valley and Carneros Region, except for areas specified as groundwater deficient areas. Groundwater deficient areas are areas that have been determined by the public works department as having a history of problems with groundwater. All other areas are classified as Mountain Areas.

Please underline your location classification below (Public Works can assist you in determining your classification if necessary):

<b>Valley Floor</b>	<b>1.0 acre feet per acre per year</b>
<b>Mountain Areas</b>	<b>0.5 acre feet per acre per year</b>
<b>MST Groundwater Deficient Area</b>	<b>0.3 acre feet per acre per year</b>

Assessor's Parcel Number(s)	Parcel Size (A)	Parcel Location Factor (B)	Allowable Water Allotment (A) X (B)
036-190-007	10.84	1	10.84

RECEIVED  
DEC 13 2016  
Napa County Planning, Building  
& Environmental Services

**Step #3:**

Using the guidelines in Attachment A, tabulate the existing and projected future water usage on the parcel(s) in acre-feet per year (af/yr). Transfer the information from the guidelines to the table below.

EXISTING USE:		PROPOSED USE:	
Residential	<u>0.5</u> af/yr	Residential	<u>0</u> af/yr
Farm Labor Dwelling	_____ af/yr	Farm Labor Dwelling	_____ af/yr
Winery	<u>1.18</u> af/yr	Winery	<u>1.42</u> af/yr
Commercial	_____ af/yr	Commercial	_____ f/yr
Vineyard*	<u>4.2</u> af/yr	Vineyard*	<u>4.2</u> af/yr
Other Agriculture	_____ af/yr	Other Agriculture	_____ af/yr
Landscaping	<u>0.3</u> af/yr	Landscaping	<u>0.3</u> af/yr
Other Usage (List Separately):		Other Usage (List Separately):	
<u>Kitchen/tasting</u>	<u>0</u> af/yr	<u>Kitchen/tasting</u>	<u>0.03</u> af/yr
_____	_____ af/yr	_____	_____ af/yr
_____	_____ af/yr	_____	_____ af/yr

TOTAL: 6.18 af/yr  
\_\_\_\_\_ gallons\*\*

TOTAL: 5.95 af/yr  
TOTAL: \_\_\_\_\_ gallons\*\*

Is the proposed use less than the existing usage?  Yes  No  Equal

**Step #4:**

Provide any other information that may be significant to this analysis. For example, any calculations supporting your estimates, well test information including draw down over time, historical water data, visual observations of water levels, well drilling information, changes in neighboring land uses, the usage if other water sources such as city water or reservoirs, the timing of the development, etc. Use additional sheets if necessary.

The Modified use permit is being submitted to reflect current land use as well as proposed improvements for for wine tasting events. Robert Biale Vineyards 2001 UP - #00271 allowed up to 40,000 gal/yr for winery production. RBV has historically produced between 45,000 to 55,000 gal/yr of wine over the last 5 years. To date there has been no changes to water availability or consumption that warrant or show any significant variance to the groundwater.

Increased wine production has occurred through utilization of off site grapes. No change in parcel vineyards has occurred. Slight decrease in overall water usage reflects; (1) increase in wine production to 60,000 gal/yr; (2) new VIP tasting area; and (3) converted Storage Building tasting room with kitchen which is more than offset by the elimination of the residential water use. Kitchen catering events were estimated based on 2 events/month for a 5 month period with a 1000 gal/event or about 0.03 af/yr.

**Conclusion:** Congratulations! Just sign the form and you are done! Public works staff will now compare your projected future water usage with a threshold of use as determined for your parcel(s) size, location, topography, rainfall, soil types, historical water data for your area, and other hydrogeologic information. They will use the above information to evaluate if your proposed project will have a detrimental effect on groundwater levels and/or neighboring well levels. Should that evaluation result in a determination that your project may adversely impact neighboring water levels, a phase two water analysis may be required. You will be advised of such a decision.

Signature: Stephen A. Gonzalez

Date: 11/14/2016 Phone: (530) 891-1710

RECEIVED

DEC 13 2016

Napa County Planning Building & Environmental Services

Plot Date: December 09, 2016 - 7:08 am  
 File Name: S:\work\16-5491 Biale Winery Expansion\CADD\Sheets\Grading Plan.dwg



SCALE 0 750 1500 3000 ft

**NICHOLS  
 MELBURG  
 ROSSETTO**  
 ARCHITECTS + ENGINEERS  
 555 MAIN STREET, SUITE 300  
 CHICO, CA 95928  
 (530) 891-1710 (530) 891-0138 FAX



**WELL VICINITY MAP**  
 Use Permit Modification  
 Robert Biale Vineyards

A  
 1

DR. SAG  
 DT. 08/25/2016  
 SC. AS NOTED  
 NO. 16-5491

Napa County Planning Building  
 & Environmental Services

Plot Date: December 09, 2016 - 7:05 am  
 File Name: S:\work\16-5491 Biale Winery Expansion\CADD\Sheets\Grading Plan.dwg

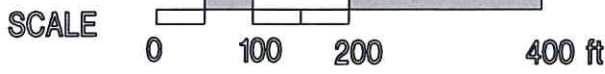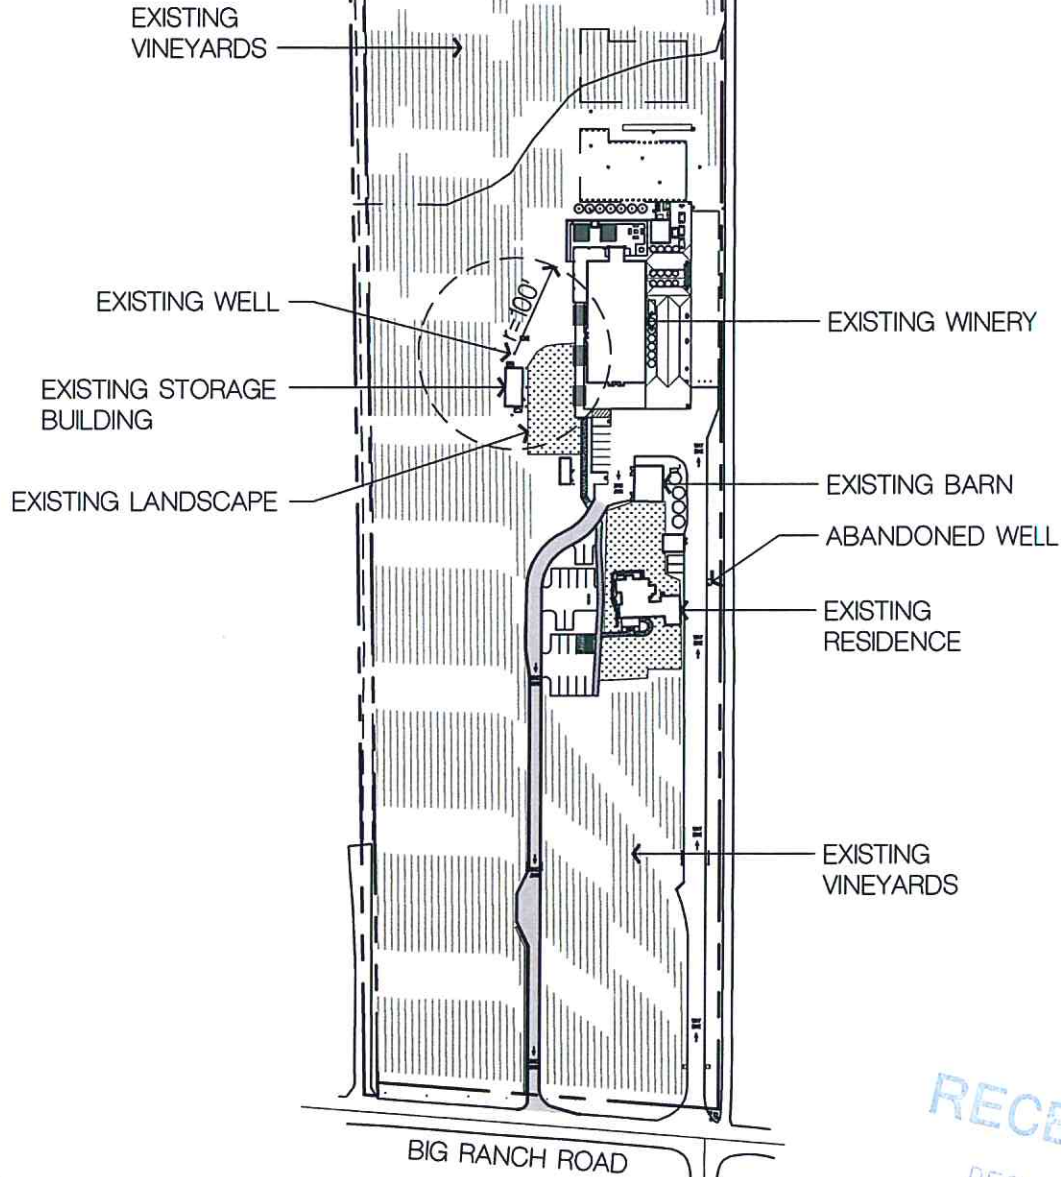

**RECEIVED**  
 DEC 13 2016  
 Napa County Planning, Building  
 & Environmental Services

**NICHOLS  
 MELBURG  
 ROSSETTO**  
 ARCHITECTS + ENGINEERS  
 555 MAIN STREET, SUITE 300  
 CHICO, CA. 95928  
 (530) 891-1710 (530) 891-0138 FAX

**SITE PLAN**  
 Use Permit Modification  
 Robert Biale Vineyards

A
2

DR. SAG
DT. 08/25/2016
SC. AS NOTED
NO. 16-5491

**NAPA COUNTY UNIFIED PROGRAM CONSOLIDATED FORM  
 FACILITY INFORMATION  
 BUSINESS ACTIVITIES**

**I. FACILITY IDENTIFICATION**

FACILITY ID # (Agency Use Only)																		EPA ID # (Hazardous Waste Only)	
BUSINESS NAME (Same as Facility Name of DBA-Doing Business As)																			
BUSINESS SITE ADDRESS <b>Robert Biale Vineyards</b>																			
BUSINESS SITE CITY <b>4038 Big Ranch Road Napa</b>																	104	CA	ZIP CODE <b>94558</b>
CONTACT NAME <b>Robert Biale</b>																	106	PHONE <b>707-257-7555</b>	

**II. ACTIVITIES DECLARATION**

**NOTE: If you check YES to any part of this list, please submit the Business Owner/Operator Identification page.**

Does your facility...	If Yes, please complete these pages of the UPCF....
<b>A. HAZARDOUS MATERIALS</b> Have on site (for any purpose) at any one time, hazardous materials at or above 55 gallons for liquids, 500 pounds for solids, or 200 cubic feet for compressed gases (include liquids in ASTs and USTs); or the applicable Federal threshold quantity for an extremely hazardous substance specified in 40 CFR Part 355, Appendix A or B; or handle radiological materials in quantities for which an emergency plan is required pursuant to 10 CFR Parts 30, 40 or 70?	<input type="checkbox"/> YES <input type="checkbox"/> NO   4 HAZARDOUS MATERIALS INVENTORY – CHEMICAL DESCRIPTION
<b>B. REGULATED SUBSTANCES</b> Have Regulated Substances stored onsite in quantities greater than the threshold quantities established by the California Accidental Release prevention Program (CalARP)?	<input type="radio"/> YES <input checked="" type="radio"/> NO   4a Coordinate with your local agency responsible for CalARP.
<b>C. UNDERGROUND STORAGE TANKS (USTs)</b> Own or operate underground storage tanks?	<input type="radio"/> YES <input checked="" type="radio"/> NO   5 UST FACILITY (Formerly SWRCB Form A) UST TANK (one page per tank) (Formerly Form B)
<b>D. ABOVE GROUND PETROLEUM STORAGE</b> Own or operate ASTs above these thresholds: Store greater than 1,320 gallons of petroleum products (new or used) in aboveground tanks or containers.	<input type="radio"/> YES <input checked="" type="radio"/> NO   8 NO FORM REQUIRED TO CUPAs
<b>E. HAZARDOUS WASTE</b> Generate hazardous waste?	<input type="radio"/> YES <input checked="" type="radio"/> NO   9 EPA ID NUMBER – provide at the top of this page
Recycle more than 100 kg/month of excluded or exempted recyclable materials (per HSC 25143.2)?	<input type="radio"/> YES <input checked="" type="radio"/> NO   10 RECYCLABLE MATERIALS REPORT (one per recycler)
Treat hazardous waste on-site?	<input type="radio"/> YES <input checked="" type="radio"/> NO   11 ON-SITE HAZARDOUS WASTE TREATMENT – FACILITY ON-SITE HAZARDOUS WASTE TREATMENT – UNIT (one page per unit)
Treatment subject to financial assurance requirements (for Permit by Rule and Conditional Authorization)?	<input type="radio"/> YES <input type="radio"/> NO   12 CERTIFICATION OF FINANCIAL ASSURANCE
Consolidate hazardous waste generated at a remote site?	<input type="radio"/> YES <input type="radio"/> NO   13 REMOTE WASTE / CONSOLIDATION SITE ANNUAL NOTIFICATION
Need to report the closure/removal of a tank that was classified AS hazardous waste and cleaned on-site?	<input type="radio"/> YES <input type="radio"/> NO   14 HAZARDOUS WASTE TANK CLOSURE CERTIFICATION
Generate in any single calendar month 1,000 kilograms (kg) (2,200 pounds) or more of federal RCRA hazardous waste, or generate in any single calendar month, or accumulate at any time, 1 kg (2.2 pounds) of RCRA acute hazardous waste; or generate or accumulate at any time more than 100 kg (220 pounds) of spill cleanup materials contaminated with RCRA acute hazardous waste.	<input type="radio"/> YES <input checked="" type="radio"/> NO   14a Obtain federal EPA ID Number, file Biennial Report (EPA Form 8700-13A/B), and satisfy requirements for RCRA Large Quantity Generator.
Household Hazardous Waste (HHW) Collection site?	<input type="radio"/> YES <input checked="" type="radio"/> NO   14b See CUPA for required forms.

<b>F. LOCAL REQUIREMENTS</b> (You may also be required to provide additional information by your CUPA or local agency.)	15
--	----

**RECEIVED** UPCF Rev. (12/2007)

1-9-2016  
 Napa County Planning Building

# Checklist of Voluntary Greenhouse Gas Emission Reduction Measures



An addendum to the Entitlement Application and a supplement for Initial Studies as required by CEQA

PROJECT NAME	Biale Vineyards		
PROJECT ADDRESS	4038 Big Ranch Road Napa, CA		
APPLICANT	Chris Dearden		
CONTACT INFO	chris@biale.com	707-257-7555	
	email	phone	



	yes	no	I don't know
1 Have you designed to U.S.G.B.C.™ LEED™ or Build It Green™ standards? If yes, please include a copy of their required spreadsheets.	<input type="checkbox"/>	<input checked="" type="checkbox"/>	<input type="checkbox"/>
2 Do you have an integrated design team? if yes, please list: <u>Stephen A. Gonsalves, LEED AP</u>	<input checked="" type="checkbox"/>	<input type="checkbox"/>	<input type="checkbox"/>
<b>3 SITE DESIGN</b>			
3.1 Does your design encourage community gathering and is it pedestrian friendly?	<input type="checkbox"/>	<input checked="" type="checkbox"/>	<input type="checkbox"/>
3.2 Are you building on existing disturbed areas?	<input type="checkbox"/>	<input type="checkbox"/>	N/A
<b>3.3 Landscape Design</b>			
3.31 native plants?	<input checked="" type="checkbox"/>	<input type="checkbox"/>	<input type="checkbox"/>
3.32 drought tolerant plants?	<input checked="" type="checkbox"/>	<input type="checkbox"/>	<input type="checkbox"/>
3.33 Pierce Disease resistant planting?	<input checked="" type="checkbox"/>	<input type="checkbox"/>	<input type="checkbox"/>
3.34 Fire resistant planting?	<input checked="" type="checkbox"/>	<input type="checkbox"/>	<input type="checkbox"/>
3.35 Are you restoring open space and/or habitat?	<input type="checkbox"/>	<input checked="" type="checkbox"/>	<input type="checkbox"/>
3.36 Are you harvesting rain water on site?	<input type="checkbox"/>	<input checked="" type="checkbox"/>	<input type="checkbox"/>
3.37 planting large trees to act as carbon sinks?	<input type="checkbox"/>	<input checked="" type="checkbox"/>	<input type="checkbox"/>
3.38 using permeable paving materials for drive access and walking surfaces?	<input checked="" type="checkbox"/>	<input type="checkbox"/>	<input type="checkbox"/>
3.4 Does your parking lot include bicycle parking?	<input type="checkbox"/>	<input checked="" type="checkbox"/>	<input type="checkbox"/>
3.5 Do you have on-site waste water disposal?	<input checked="" type="checkbox"/>	<input type="checkbox"/>	<input type="checkbox"/>
3.6 Do have post-construction stormwater on site detention/filtration methods designed?	<input checked="" type="checkbox"/>	<input type="checkbox"/>	<input type="checkbox"/>
3.7 Have you designed in harmony with existing natural features, such as preserving existing trees or rock outcroppings?	<input checked="" type="checkbox"/>	<input type="checkbox"/>	<input type="checkbox"/>
3.8 Does the project minimize the amount of site disturbance, such as minimizing grading and/or using the existing topography in the overall site design (such as cave design)?	<input checked="" type="checkbox"/>	<input type="checkbox"/>	<input type="checkbox"/>
3.9 Is the structure designed to take advantage of natural cooling and passive solar aspects?	<input type="checkbox"/>	<input checked="" type="checkbox"/>	<input type="checkbox"/>
<b>4 ENERGY PRODUCTION &amp; EFFICIENCY</b>			
4.1 Does your facility use energy produced on site? If yes, please explain the size, location, and percentage of off-set:	<input type="checkbox"/>	<input checked="" type="checkbox"/>	<input type="checkbox"/>
4.2 Does the design include thermal mass within the walls and/or floors?	<input type="checkbox"/>	<input checked="" type="checkbox"/>	<input type="checkbox"/>
4.3 Do you intend to commission the performance of the building after it is built to ensure it performs as designed?	<input type="checkbox"/>	<input type="checkbox"/>	N/A
<b>4.4 Will your plans for construction include:</b>			
4.41 High density insulation above Title 24 standards?	<input type="checkbox"/>	<input checked="" type="checkbox"/>	<input type="checkbox"/>
4.42 Zones for heating and cooling to provide for maximum efficiency?	<input type="checkbox"/>	<input checked="" type="checkbox"/>	<input type="checkbox"/>
4.43 Energy Star™ or ultra energy efficient appliances?	<input type="checkbox"/>	<input checked="" type="checkbox"/>	<input type="checkbox"/>
4.44 A "cool" (lightly colored or reflective) or a permeable/living roof?	<input type="checkbox"/>	<input checked="" type="checkbox"/>	<input type="checkbox"/>
4.45 Timers/time-outs installed on lights (such as the bathrooms)?	<input type="checkbox"/>	<input checked="" type="checkbox"/>	<input type="checkbox"/>
If yes, please explain: _____			
<b>5 WATER CONSERVATION</b>			
5.1 Does your landscape include high-efficiency irrigation?	<input type="checkbox"/>	<input checked="" type="checkbox"/>	<input type="checkbox"/>
5.2 Does your landscape use zero potable water irrigation?	<input type="checkbox"/>	<input checked="" type="checkbox"/>	<input type="checkbox"/>
5.3 Is your project in the vicinity to connect to the Napa Sanitation reclaimed water?	<input type="checkbox"/>	<input checked="" type="checkbox"/>	<input type="checkbox"/>
5.4 Will your facility use recycled water?	<input type="checkbox"/>	<input checked="" type="checkbox"/>	<input type="checkbox"/>
5.41 If no, will you prepare for it by pre-installing dual pipes and/or purple lines?	<input type="checkbox"/>	<input type="checkbox"/>	N/A
<b>5.5 Will your plans for construction include:</b>			
5.51 a meter to track your water usage?	<input checked="" type="checkbox"/>	<input type="checkbox"/>	<input type="checkbox"/>
5.52 ultra water efficient fixtures and appliances?	<input type="checkbox"/>	<input checked="" type="checkbox"/>	<input type="checkbox"/>
5.53 a continuous hot water distribution method, such as an on-demand pump?	<input type="checkbox"/>	<input checked="" type="checkbox"/>	<input type="checkbox"/>
5.54 a timer to insure that the systems are run only at night/early morning?	<input checked="" type="checkbox"/>	<input type="checkbox"/>	<input type="checkbox"/>

	yes	no	I don't know
<b>6 MATERIAL RECYCLING</b>			
6.1 Are you using reclaimed materials?		X	
If yes, what and where: _____			
6.2 Are you using recycled construction materials-			N/A
6.21 finish materials?			N/A
6.22 aggregate/concrete road surfaces?	X		
6.23 fly ash/slag in foundation?			N/A
6.3 Will your contractor be required to recycle and reuse construction materials as part of your contract?	X		
6.4 Does your facility provide access to recycle-		X	
6.41 Kitchen recycling center?		X	
6.42 Recycling options at all trash cans?		X	
6.43 Do you compost green waste?		X	
6.44 Provide recycling options at special events?	X		
<b>7 NATURAL RESOURCES</b>			
7.1 Will you be using certified wood that is sustainably harvested in construction?		X	
7.2 Will you be using regional (within 500 miles) building materials?	X		
7.3 Will you be using rapidly renewable materials, such as bamboo?		X	
7.4 Will you apply optimal value engineering (studs & rafters at 24" on center framing)?	X		
7.5 Have you considered the life-cycle of the materials you chose?	X		
<b>8 INDOOR AIR QUALITY</b>			
8.1 Will you be using low or no emitting finish and construction materials indoors-			
8.11 Paint?	X		
8.12 Adhesives and Sealants?	X		
8.13 Flooring?	X		
8.14 Framing systems?		X	
8.15 Insulation?	X		
8.2 Does the design allow for maximum ventilation?		X	
8.3 Do you plan for a wood burning fireplace (US EPA Phase II certified)?		X	
8.4 Does your design include dayliting, such as skylights?		X	
<b>9 TRANSPORTATION DEMAND MANAGMENTMENT</b>			
9.1 After your project is complete, will you offer your employees incentives to carpool, bike, or use transit?	X		
9.2 After your project is complete, will you allow your employees to telecommute or have alternative work schedules?	X		
9.3 Does your project include design features that encourage alternatives modes of transportation, such as preferred parking for carpooling, ridesharing, electric vehicles? secured bicycle parking, safe bicycle access? loading zones for buses/large taxi services?		X	
		X	
		X	
9.4 How close is your facility to public transportation? Three miles			
<b>10 Are there any superior environmental/sustainable features of your project that should be noted?</b>			
_____			
_____			
<b>11 What other studies or reports have you done as part of preparing this application?</b>			
1	Wastewater analysis		
2	Water availability analysis		
3	Traffic analysis		
4			
<b>12 If your project involves an addition or modification to an existing building, are you planning to improve energy conservation of existing space (such as insulation, new windows, HVAC, etc.)?</b>			
	X		
If yes, please describe: Storage Building conversion will include insulation and new windows			
<b>13 Once your facility is in operation, will you:</b>			
13.1 calculate your greenhouse gas emissions?		X	
13.2 implement a GHG reduction plan?		X	
13.3 have a written plan to reduce your vehicle miles traveled of your operations and employee's commute?		X	
<b>14 Does your project provide for education of green/sustainable practices?</b>			
		X	
If yes, please describe: _____			
<b>15 Any comments, suggestions, or questions in regards to the County's efforts to reduce greenhouse gases?</b>			
_____			
_____			
_____			

Form filed out by: Stephen A. Gonsalves, LEED AP

Please feel free to include additional sheets of paper as necessary.

Plot Date: September 07, 2016 - 9:26 am  
 File Name: S:\Work\16-5491 Biale Winery Expansion\CADD\Sheets\Grading\Perching

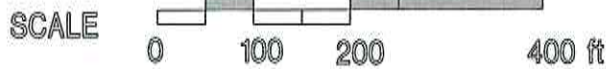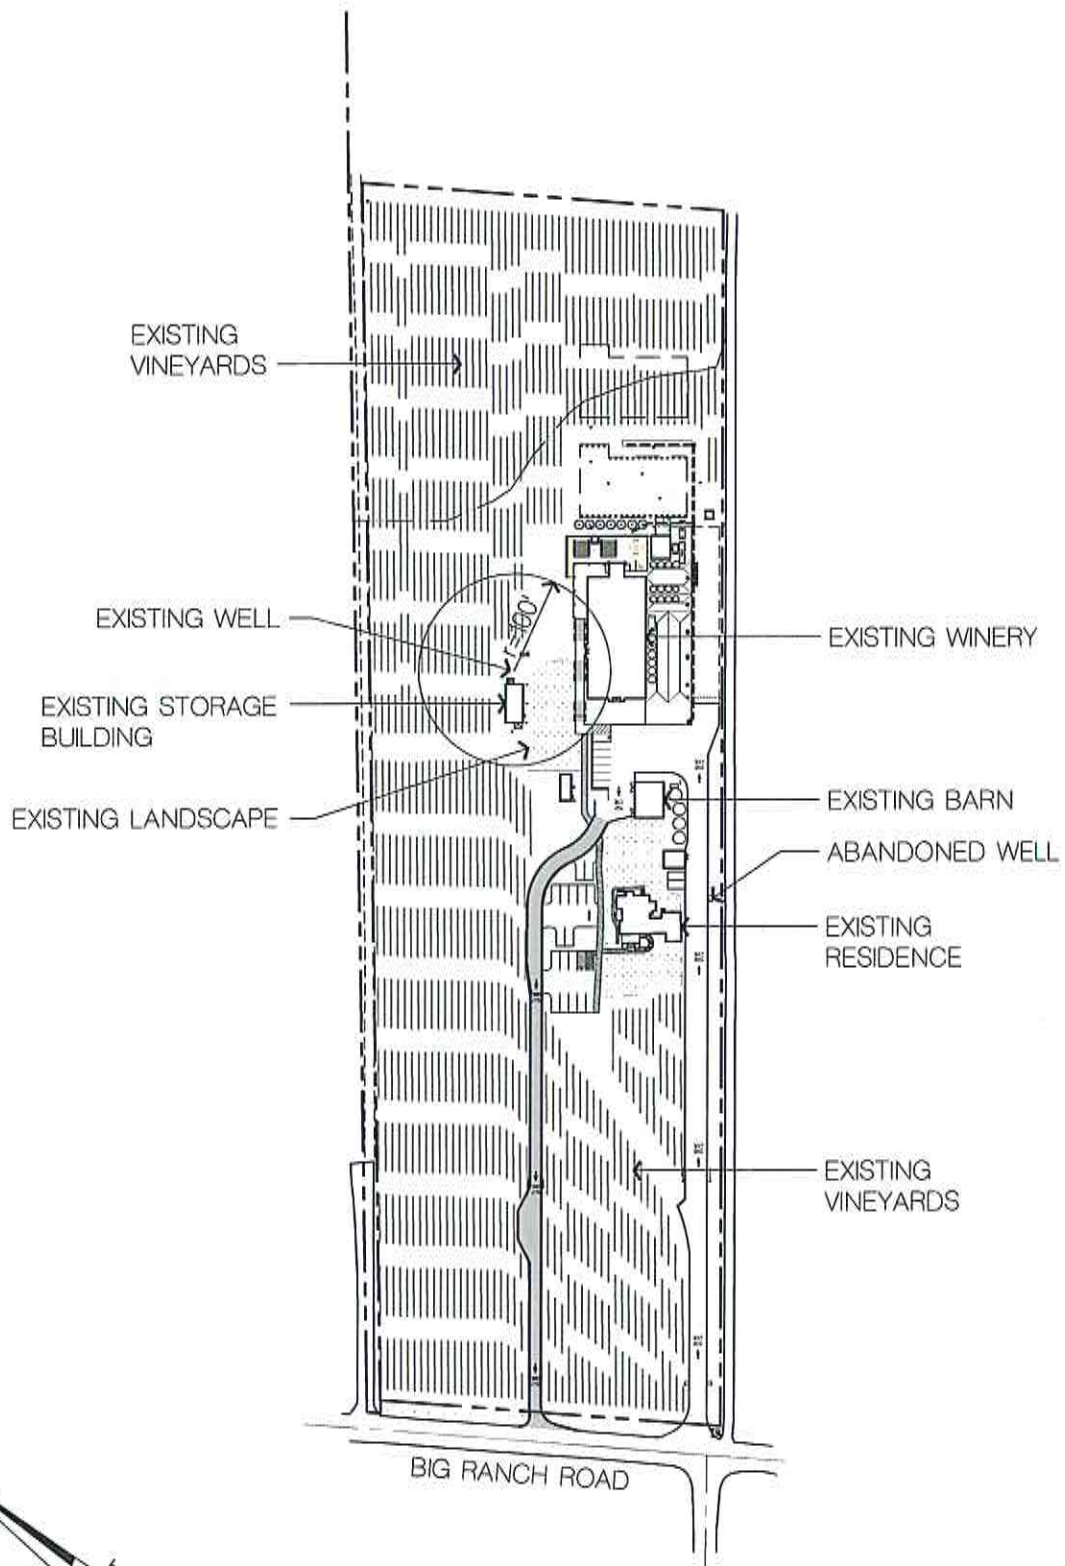

**NICHOLS  
 MELBURG  
 ROSSETTO**  
 ARCHITECTS + ENGINEERS  
 555 MAIN STREET, SUITE 300  
 CHICO, CA 95928  
 (530) 891-1710 (530) 891-0138 FAX

**SITE PLAN**

Use Permit Modification  
 Robert Biale Vineyards

A
2

DR. SAG
DT. 08/25/2016
SC. AS NOTED
NO. 16-5491





Project name & APN: Robert Biale Vineyards Use Permit Modification

Project number if known:

Contact person: Stephen A. Gonsalves

Contact email & phone number: 530.891.1710 gonsalves@nmrdesign.com

Today's date: October 4, 2016

A Tradition of Stewardship  
A Commitment to Service

## Voluntary Best Management Practices Checklist for Development Projects

Napa County General Plan Policy CON-65 (e) and Policy CON-67 (d) requires the consideration of Greenhouse Gas (GHG) emissions in the review of discretionary projects and to promote and encourage "green building" design. The below Best Management Practices (BMPs) reduce GHG emissions through energy and water conservation, waste reduction, efficient transportation, and land conservation. The voluntary checklist included here should be consulted early in the project and be considered for inclusion in new development. It is not intended, and likely not possible for all projects to adhere to all of the BMPs. Rather, these BMPs provide a portfolio of options from which a project could choose, taking into consideration cost, co-benefits, schedule, and project specific requirements. Please check the box for all BMPs that your project proposes to include and include a separate narrative if your project has special circumstances.

### Practices with Measurable GHG Reduction Potential

The following measures reduce GHG emissions and if needed can be calculated. They are placed in descending order based on the amount of emission reduction potential.

Already Doing	Plan To Do	ID #	BMP Name
<input type="checkbox"/>	<input type="checkbox"/>	<b>BMP-1</b>	<b>Generation of on-site renewable energy</b> <i>If a project team designs with alternative energy in mind at the conceptual stage it can be integrated into the design. For instance, the roof can be oriented, sized, and engineered to accommodate photovoltaic (PV) panels. If you intend to do this BMP, please indicate the location of the proposed PV panels on the building elevations or the location of the ground mounted PV array on the site plan. Please indicate the total annual energy demand and the total annual kilowatt hours produced or purchased and the potential percentage reduction of electrical consumption. Please contact staff or refer to the handout to calculate how much electrical energy your project may need.</i>  <hr/> <hr/> <hr/> <hr/>
<input type="checkbox"/>	<input type="checkbox"/>	<b>BMP-2</b>	<b>Preservation of developable open space in a conservation easement</b> <i>Please indicate the amount and location of developable land (i.e.: under 30% slope and not in creek setbacks or environmentally sensitive areas for vineyards) conserved in a permanent easement to prohibit future development.</i>  <hr/> <hr/>

Already Doing    Plan To Do

**BMP-3 Habitat restoration or new vegetation (e.g. planting of additional trees over 1/2 acre)**

*Napa County is famous for its land stewardship and preservation. Restoring areas within the creek setback reduces erosion potential while planting areas that are currently hardscape (such as doing a bio-retention swale rather than underground storm drains) reduces storm water and helps the groundwater recharge. Planting trees can also increase the annual uptake of CO2e and add the County's carbon stock.*

**BMP-4 Alternative fuel and electrical vehicles in fleet**

*The magnitude of GHG reductions achieved through implementation of this measure varies depending on the analysis year, equipment, and fuel type replaced.*

**Number of total vehicles** \_\_\_\_\_

**Typical annual fuel consumption or VMT** \_\_\_\_\_

**Number of alternative fuel vehicles** \_\_\_\_\_

**Type of fuel/vehicle(s)** \_\_\_\_\_

**Potential annual fuel or VMT savings** \_\_\_\_\_

**BMP-5 Exceed Title 24 energy efficiency standards: Build to CALGREEN Tier 2**

*The California Building Code update effective January 1, 2011 has new mandatory green building measures for all new construction and has been labeled CALGREEN. CALGREEN provides two voluntary higher levels labeled CALGREEN Tier I and CALGREEN Tier II. Each tier adds a further set of green building measures that go above and beyond the mandatory measures of the Code. In both tiers, buildings will use less energy than the current Title 24 California Energy Code. Tier I buildings achieve at least a 15% improvement and Tier 2 buildings are to achieve a 30% improvement. Both tiers require additional non-energy prerequisites, as well as a certain number of elective measures in each green building category (energy efficiency, water efficiency, resource conservation, indoor air quality and community).*

**BMP-6 Vehicle Miles Traveled (VMT) reduction plan**

*Selecting this BMP states that the business operations intend to implement a VMT reduction plan reducing annual VMTs by at least 15%.*

Tick box(es) for what your Transportation Demand Management Plan will/does include:

- employee incentives
- employee carpool or vanpool
- priority parking for efficient transportation (hybrid vehicles, carpools, etc.)
- bike riding incentives
- bus transportation for large marketing events
- Other: \_\_\_\_\_

Estimated annual VMT \_\_\_\_\_

Potential annual VMT saved \_\_\_\_\_

% Change \_\_\_\_\_

Already Plan  
Doing To Do

- BMP-7 Exceed Title 24 energy efficiency standards: Build to CALGREEN Tier 1**  
*See description below under BMP-5.*
- 
- 

- BMP-8 Solar hot water heating**  
*Solar water heating systems include storage tanks and solar collectors. There are two types of solar water heating systems: active, which have circulating pumps and controls, and passive, which don't. Both of them would still require additional heating to bring them to the temperature necessary for domestic purposes. They are commonly used to heat swimming pools.*
- 
- 

- BMP-9 Energy conserving lighting**  
*Lighting is approximately 25% of typical electrical consumption. This BMP recommends installing or replacing existing light bulbs with energy-efficient compact fluorescent (CF) bulbs or Light Emitting Diode (LED) for your most-used lights. Although they cost more initially, they save money in the long run by using only 1/4 the energy of an ordinary incandescent bulb and lasting 8-12 times longer. Typical payback from the initial purchase is about 18 months.*
- 
- 

- BMP-10 Energy Star Roof/Living Roof/Cool Roof**  
*Most roofs are dark-colored. In the heat of the full sun, the surface of a black roof can reach temperatures of 158 to 194 °F. Cool roofs, on the other hand, offer both immediate and long-term benefits including reduced building heat-gain and savings of up to 15% the annual air-conditioning energy use of a single-story building. A cool roof and a green roof are different in that the green roof provides living material to act as a both heat sink and thermal mass on the roof which provides both winter warming and summer cooling. A green (living) roof also reduces storm water runoff.*

All buildings on site are existing but cooling roofing products will be utilized when roof replacement is required.

---

---

- BMP-11 Bicycle Incentives**  
*Napa County Zoning Ordinance requires 1 bicycle rack per 20 parking spaces (§18.110.040). Incentives that go beyond this requirement can include on-site lockers for employees, showers, and for visitor's items such as directional signs and information on biking in Napa. Be creative!*
- 
- 

- BMP-12 Bicycle route improvements**  
*Refer to the Napa County Bicycle Plan (NCPTA, December 2011) and note on the site plan the nearest bike routes. Please note proximity, access, and connection to existing and proposed bike lanes (Class I: Completely separated right-of-way; Class II: Striped bike lane; Class III: Signed Bike Routes). Indicate bike accessibility to project and any proposed improvements as part of the project on the site plan or describe below.*
- 
-

Already Doing    Plan To Do

**BMP-13 Connection to recycled water**

*Recycled water has been further treated and disinfected to provide a non-potable (non-drinking water) water supply. Using recycled water for irrigation in place of potable or groundwater helps conserve water resources.*

---

---

**BMP-14 Install Water Efficient fixtures**

*WaterSense, a partnership program by the U.S. Environmental Protection Agency administers the review of products and services that have earned the WaterSense label. Products have been certified to be at least 20 percent more efficient without sacrificing performance. By checking this box you intend to install water efficient fixtures or fixtures that conserve water by 20%.*

*All plumbing fixtures are existing but water efficient fixtures will be utilized when replacement is necessary*

---

---

**BMP-15 Low-impact development (LID)**

*LID is an approach to land development (or re-development) that works with nature to manage storm water as close to its source as possible. LID employs principles such as preserving and recreating natural landscape features, minimizing effective imperviousness to create functional and appealing site drainage that treat storm water as a resource rather than a waste product. There are many practices that have been used to adhere to these principles such as bioretention facilities, rain gardens, vegetated rooftops, rain barrels, and permeable pavements. By implementing LID principles and practices, water can be managed in a way that reduces the impact of built areas and promotes the natural movement of water within an ecosystem or watershed. Please indicate on the site or landscape plan how your project is designed in this way.*

---

---

**BMP-16 Water efficient landscape**

*If your project is a residential development proposing in excess of 5,000 sq. ft. or a commercial development proposing in excess of 2,500 sq. ft. The project will be required to comply with the Water Efficient Landscape Ordinance (WELO).*

*Please check the box if you will be complying with WELO or if your project is smaller than the minimum requirement and you are still proposing drought tolerant, zeroscape, native plantings, zoned irrigation or other water efficient landscape.*

*Water efficient landscape materials will be utilized in the proposed Back Porch Expansion*

---

---

**BMP-17 Recycle 75% of all waste**

*Did you know that the County of Napa will provide recycling collectors for the interior of your business at no additional charge? With single stream recycling it is really easy and convenient to meet this goal. To qualify for this BMP, your business will have to be aggressive, proactive and purchase with this goal in mind.*

---

---

Already Plan  
Doing To Do

**BMP-18 Compost 75% food and garden material**

*The Napa County food composting program is for any business large or small that generates food scraps and compostable, including restaurants, hotels, wineries, assisted living facilities, grocery stores, schools, manufacturers, cafeterias, coffee shops, etc. All food scraps (including meat & dairy) as well as soiled paper and other compostable - see <http://www.naparecycling.com/foodcomposting> for more details.*

---

---

**BMP-19 Implement a sustainable purchasing and shipping programs**

*Environmentally Preferable Purchasing (EPP) or Sustainable Purchasing refers to the procurement of products and services that have a reduced effect on human health and the environment when compared with competing products or services that serve the same purpose. By selecting this BMP, you agree to have an EPP on file for your employees to abide by.*

---

---

**BMP-20 Planting of shade trees within 40 feet of the south side of the building elevation**

*Well-placed trees can help keep your building cool in summer. If you choose a deciduous tree after the leaves drop in autumn, sunlight will warm your building through south and west-facing windows during the colder months. Well-designed landscaping can reduce cooling costs by 20%. Trees deliver more than energy and cost savings; they are important carbon sinks. Select varieties that require minimal care and water, and can withstand local weather extremes. Fruit or nut trees that produce in your area are great choices, providing you with local food as well as shade. Please use the site or landscape plan to indicate where trees are proposed and which species you are using.*

---

---

**BMP-21 Electrical Vehicle Charging Station(s)**

*As plug-in hybrid electric vehicles (EV) and battery electric vehicle ownership is expanding, there is a growing need for widely distributed accessible charging stations. Please indicate on the site plan where the station will be.*

---

---

**BMP-22 Public Transit Accessibility**

*Refer to <http://www.ridethevine.com/vine> and indicate on the site plan the closest bus stop/route. Please indicate if the site is accessed by transit or by a local shuttle. Provide an explanation of any incentives for visitors and employees to use public transit. Incentives can include bus passes, informational hand outs, construction of a bus shelter, transportation from bus stop, etc.*

---

---

Already Plan  
Doing To Do

**BMP-23**

**Site Design that is oriented and designed to optimize conditions for natural heating, cooling, and day lighting of interior spaces, and to maximize winter sun exposure; such as a cave.**  
*The amount of energy a cave saves is dependent on the type of soil, the microclimate, and the user's request for temperature control. Inherently a cave or a building buried into the ground saves energy because the ground is a consistent temperature and it reduces the amount of heating and cooling required. On the same concept, a building that is oriented to have southern exposure for winter warmth and shading for summer cooling with an east-west cross breeze will naturally heat, cool, and ventilate the structure without using energy. Please check this box if your design includes a cave or exceptional site design that takes into consideration the natural topography and sitting. Be prepared to explain your approach and estimated energy savings.*

---

---

**BMP-24 Limit the amount of grading and tree removal**

*Limiting the amount of earth disturbance reduces the amount of CO2 released from the soil and mechanical equipment. This BMP is for a project design that either proposes a project within an already disturbed area proposing development that follows the natural contours of the land, and that doesn't require substantial grading or tree removal.*

*Plans for a new driveway and parking areas have been created with the specific intent to save all existing trees.*

---

---

**BMP-25 Will this project be designed and built so that it could qualify for LEED?**

**BMP-25 (a)**

**LEED™ Silver** (check box BMP-25 and this one)

**BMP-25 (b)**

**LEED™ Gold** (check box BMP-25, BMP-25 (a), and this box)

**BMP-25 (c)**

**LEED™ Platinum** (check all 4 boxes)

## Practices with Un-Measured GHG Reduction Potential

---

**BMP-26 Are you, or do you intend to become a Certified Green Business or certified as a "Napa Green Winery"?**

*As part of the Bay Area Green Business Program, the Napa County Green Business Program is a free, voluntary program that allows businesses to demonstrate the care for the environment by going above and beyond business as usual and implementing environmentally friendly business practices. For more information check out the Napa County Green Business and Winery Program at [www.countyofnapa.org](http://www.countyofnapa.org).*

**BMP-27 Are you, or do you intend to become a Certified "Napa Green Land"?**

*Napa Green Land, fish friendly farming, is a voluntary, comprehensive, "best practices" program for vineyards. Napa Valley vintners and growers develop farm-specific plans tailored to protect and enhance the ecological quality of the region, or create production facility programs that reduce energy and water use, waste and pollution. By selecting this measure either you are certified or you are in the process of certification.*

Already Plan  
Doing To Do

- BMP-28 Use of recycled materials**

*There are a lot of materials in the market that are made from recycled content. By ticking this box, you are committing to use post-consumer products in your construction and your ongoing operations.*

Materials with high recycled content will be utilized for new driveway construction and existing building remodels

---

- BMP-29 Local food production**

*There are many intrinsic benefits of locally grown food, for instance reducing the transportation emissions, employing full time farm workers, and improving local access to fresh fruits and vegetables.*

---

- BMP-30 Education to staff and visitors on sustainable practices**

*This BMP can be performed in many ways. One way is to simply put up signs reminding employees to do simple things such as keeping the thermostat at a consistent temperature or turning the lights off after you leave a room. If the project proposes alternative energy or sustainable winegrowing, this BMP could include explaining those business practices to staff and visitors.*

---

- BMP-31 Use 70-80% cover crop**

*Cover crops reduce erosion and the amount of tilling which is required, which releases carbon into the environment.*

- BMP-32 Retain biomass removed via pruning and thinning by chipping the material and reusing it rather than burning on-site**

*By selecting this BMP, you agree not to burn the material pruned on site.*

- BMP-33 Are you participating in any of the above BMPS at a 'Parent' or outside location?**

---

---

---

---

---

- BMP-34 Are you doing anything that deserves acknowledgement that isn't listed above?**

---

---

---

---

**Comments and Suggestions on this form?**

---

---

---

---



A Tradition of Stewardship  
A Commitment to Service

Planning, Building & Environmental Services

1195 Third Street, Suite 210  
Napa, CA 94559  
www.countyofnapa.org

David Morrison  
Director

**PROJECT GUIDANCE FOR  
STORMWATER QUALITY COMPLIANCE**

**PROJECT INFORMATION**

Project Name	Project Number
Robert Biale Vineyards Use Permit Modification	
Project Address	Assessor's Parcel Number
4038 Big Ranch Road, Napa, CA	036 190 007
Existing Development Permits Under Review or Issued	
03088-UP	

**EROSION & SEDIMENT CONTROL PLAN (ESCP) APPLICABILITY**

Under Provision E.10 of a statewide Phase II municipal stormwater NPDES permit reissued by the California State Water Resource Control Board in 2013, requires Napa County to establish and enforce an erosion and sediment control program to minimize the discharge of sediment and construction related pollutants. All individuals undertaking public or private construction or ground disturbing activities must take steps to prevent the discharge of pollutants resulting from these activities. Specified projects that require local permits or trigger ground disturbance thresholds must prepare plans describing the BMPs that will be implemented. Refer to Napa County's Erosion and Sediment Control Plan Guidance Table 3, Levels of Erosion and Sediment Control Requirements, for a summary of the general levels of requirements that are further described in the guidance document. Please respond to the following questions.

- Does the project require a Grading Permit?      Yes       No
- Does the project proposed soil disturbance greater or equal to 10,000 square feet?      Yes       No   
 Proposed Disturbed Soil Area:  sq.ft.       acres
- Does the project propose soil disturbance on slopes greater or equal to 5%?      Yes       No   
 Maximum Percent Slope:
- Does the project propose installation of new and/or reconstructed storm drains which discharge to a municipal storm system or receiving water body?      Yes       No

*For County Use Only:*

	High	Medium	Low	N/A
Threat to Water Quality	<input type="checkbox"/>	<input type="checkbox"/>	<input type="checkbox"/>	<input type="checkbox"/>

Construction General Permit WDID# (if applicable):





**POST-CONSTRUCTION STORMWATER CONTROL PLAN (SCP) APPLICABILITY**

Under Provision E.12 of a statewide Phase II municipal stormwater NPDES permit reissued by the California State Water Resource Control Board in 2013, requires Napa County to regulate development projects to control pollutants in runoff from newly created or replaced impervious surface. Prior to submittal of a use, building, or grading permit, applicants must determine the Project Type, Project Requirements and submittal requirements. Refer to Napa County's BASMAA Post-Construction Manual Table 1-1, Requirements at a Glance, for a summary of project type requirements.

**TYPE OF PROJECT:**

Single Family Dwelling\*                       Larger Plan of Development\*\*

Commercial / Industrial / Non-Residential                       Roads / Linear-Utility Project (LUP)

Total New or Replaced Impervious Surface Area (sq.ft.):	2,898
Total Pre-Project Impervious Surface Area (sq.ft.): Total	59,106
Post-Project Impervious Surface Area (sq.ft.):	62,004

\*Single-Family home or dwelling unit means a dwelling unit containing not more than one kitchen, designed to be occupied by not more than one family, and includes a manufactured home as defined in Section 18.08.360 which is installed on a permanent foundation and certified under the National Manufactured Housing Construction and Safety Standards Act of 1974 (42 U.S.C. Sections 5401 and following).

\*\*Larger Plan of Development means a development consisting of more than a single family home or dwelling unit and two accessory structures (e.g. detached garage, guest cottage, pool house, etc.).

**For County Use Only:**

	Single-Family Dwelling	Small Project	Regulated Project	Roads & LUPs	N/A
Project Category	<input type="checkbox"/>	<input type="checkbox"/>	<input type="checkbox"/>	<input type="checkbox"/>	<input type="checkbox"/>

Operation & Maintenance Agreement Required:                      Yes                       No

I hereby certify that the information presented herein by myself or my representative is accurate and complete. Incorrect information on proposed activities or uses may delay your application(s) or permit(s).

Name of Owner / Agent:                       Title:

Signature of Owner / Agent:                       Date:

Copyright © 2016

ALL RIGHTS RESERVED. NO PART OF THIS DOCUMENT MAY BE REPRODUCED OR TRANSMITTED IN ANY FORM OR BY ANY MEANS, ELECTRONIC OR MECHANICAL, INCLUDING PHOTOCOPYING, RECORDING, OR BY ANY INFORMATION STORAGE AND RETRIEVAL SYSTEM, WITHOUT THE WRITTEN PERMISSION OF THE CONSULTANT.



**NICHOLS  
MELBURG  
ROSSETTO**  
ARCHITECTS + ENGINEERS  
555 MAIN STREET, SUITE 300  
CHICO, CA 95928  
916.291.1110 FAX  
916.291.1110  
WWW.NMRCA.COM

**RECEIVED**  
DEC 13 2016  
Napa County Planning Building  
& Environmental Services

LICENSE STAMPS

PROJECT NAME  
**WINERY  
EXPANSION  
FOR**



**ROBERT BIALE  
VINEYARDS**  
4028 BIG RANCH RD.  
NAPA, CA

SHEET TITLE  
**TITLE SHEET**

DRAWING STATUS  
**USE PERMIT  
MODIFICATION**

REVISIONS  
Sym. Description By Date  
AREA RECORDED 264 2/27/09

Drawn By  
Checked By  
Date Drawn  
Scale  
Job No.  
SHEET No.

**G000**

**ROBERT BIALE VINEYARDS  
P16-00396 USE PERMIT MODIFICATION PLANS**



**PROJECT TEAM:**

**OWNER:**  
**ROBERT BIALE VINEYARDS**  
4028 BIG RANCH ROAD  
NAPA, CALIFORNIA 94958  
PROJECT REP: Chris Davidson, COO  
chris@biale.com

**PLANNING CONSULTANT:**  
**LAND USE PLANNING SERVICES**  
2403 BENDERLY STREET  
NAPA, CALIFORNIA 94958  
(707) 257-7655  
judy@lup.com

**ARCHITECT:**  
**NICHOLS, MELBURG & ROSSETTO**  
555 MAIN STREET, SUITE 300  
CHICO, CALIFORNIA 95928  
(916) 861-1110  
PROJECT REP: Susan Gonzalez  
gonzales@nmrca.com

**CIVIL ENGINEER:**  
**NICHOLS, MELBURG & ROSSETTO**  
555 MAIN STREET, SUITE 300  
CHICO, CALIFORNIA 95928  
PROJECT REP: Susan Gonzalez  
gonzales@nmrca.com

**TRAFFIC ENGINEER:**  
**W-TRANS**  
401 MCGONAGH AVE, STE 201  
SANTA ROSA, CA 95407  
(707) 546-8888  
PROJECT REP: Greg Haring, PE  
greh@w-trans.com

**ENVIRONMENTAL CONSULTANT:**  
**HALING & ASSOCIATES**  
188 EATON ROAD  
CHICO, CA 95973  
(916) 342-8858  
PROJECT REP: Greg Haring, PE  
greh@haling-associates.com

**PROJECT DATA**

SEE: ASSESSORS PARCEL NO. 020206-0027  
ZONING AP (AGRICULTURAL PRESERV.)  
STREET ADDRESS 4028 BIG RANCH ROAD, NAPA, CA  
PARCEL AREA 2.04 ACRES

**VICINITY MAP**



**BOUNDARY & BENCHMARK NOTES**

1. VERTICAL DATUM BASED ON NAPA COUNTY BENCHMARK 142 78-C  
2. NO BOUNDARY SURVEY HAS BEEN CONDUCTED. PROPERTY LINES AND CORNERS SHOWN ARE BASED ON PRIOR SURVEYS.

**SHEET INDEX**

SHT. #	DESCRIPTION	SCALE
0000	TITLE SHEET	AS SHOWN
0001	CIVIL SITE PLAN	1" = 80'
0002	TRAFFIC IMPACT STATEMENT	1" = 80'
0003	WATER, SEWER, GAS, AND FLOOD CONTROL	1" = 80'
0004	LANDSCAPE ARCHITECTURE	1" = 80'
0005	ENVIRONMENTAL IMPACT STATEMENT	AS SHOWN
0006	GEOTECHNICAL ENGINEERING	AS SHOWN
0007	ARCHITECTURAL EXTERIOR ELEVATIONS	AS SHOWN
0008	ARCHITECTURAL INTERIOR ELEVATIONS	AS SHOWN
0009	ARCHITECTURAL FLOOR PLANS	AS SHOWN
0010	ARCHITECTURAL SECTION ELEVATIONS	AS SHOWN
0011	ARCHITECTURAL FOUNDATION PLAN	AS SHOWN
0012	ARCHITECTURAL FOUNDATION ELEVATIONS	AS SHOWN
0013	ARCHITECTURAL FOUNDATION WALLS	AS SHOWN
0014	ARCHITECTURAL FOUNDATION ROOF PLAN	AS SHOWN
0015	ARCHITECTURAL FOUNDATION ROOF ELEVATIONS	AS SHOWN
0016	ARCHITECTURAL FOUNDATION ROOF WALLS	AS SHOWN
0017	ARCHITECTURAL FOUNDATION ROOF FLOOR PLAN	AS SHOWN
0018	ARCHITECTURAL FOUNDATION ROOF ELEVATIONS	AS SHOWN
0019	ARCHITECTURAL FOUNDATION ROOF WALLS	AS SHOWN
0020	ARCHITECTURAL FOUNDATION ROOF FLOOR PLAN	AS SHOWN
0021	ARCHITECTURAL FOUNDATION ROOF ELEVATIONS	AS SHOWN
0022	ARCHITECTURAL FOUNDATION ROOF WALLS	AS SHOWN
0023	ARCHITECTURAL FOUNDATION ROOF FLOOR PLAN	AS SHOWN
0024	ARCHITECTURAL FOUNDATION ROOF ELEVATIONS	AS SHOWN
0025	ARCHITECTURAL FOUNDATION ROOF WALLS	AS SHOWN
0026	ARCHITECTURAL FOUNDATION ROOF FLOOR PLAN	AS SHOWN
0027	ARCHITECTURAL FOUNDATION ROOF ELEVATIONS	AS SHOWN
0028	ARCHITECTURAL FOUNDATION ROOF WALLS	AS SHOWN
0029	ARCHITECTURAL FOUNDATION ROOF FLOOR PLAN	AS SHOWN
0030	ARCHITECTURAL FOUNDATION ROOF ELEVATIONS	AS SHOWN
0031	ARCHITECTURAL FOUNDATION ROOF WALLS	AS SHOWN
0032	ARCHITECTURAL FOUNDATION ROOF FLOOR PLAN	AS SHOWN
0033	ARCHITECTURAL FOUNDATION ROOF ELEVATIONS	AS SHOWN
0034	ARCHITECTURAL FOUNDATION ROOF WALLS	AS SHOWN
0035	ARCHITECTURAL FOUNDATION ROOF FLOOR PLAN	AS SHOWN
0036	ARCHITECTURAL FOUNDATION ROOF ELEVATIONS	AS SHOWN
0037	ARCHITECTURAL FOUNDATION ROOF WALLS	AS SHOWN
0038	ARCHITECTURAL FOUNDATION ROOF FLOOR PLAN	AS SHOWN
0039	ARCHITECTURAL FOUNDATION ROOF ELEVATIONS	AS SHOWN
0040	ARCHITECTURAL FOUNDATION ROOF WALLS	AS SHOWN
0041	ARCHITECTURAL FOUNDATION ROOF FLOOR PLAN	AS SHOWN
0042	ARCHITECTURAL FOUNDATION ROOF ELEVATIONS	AS SHOWN
0043	ARCHITECTURAL FOUNDATION ROOF WALLS	AS SHOWN
0044	ARCHITECTURAL FOUNDATION ROOF FLOOR PLAN	AS SHOWN
0045	ARCHITECTURAL FOUNDATION ROOF ELEVATIONS	AS SHOWN
0046	ARCHITECTURAL FOUNDATION ROOF WALLS	AS SHOWN
0047	ARCHITECTURAL FOUNDATION ROOF FLOOR PLAN	AS SHOWN
0048	ARCHITECTURAL FOUNDATION ROOF ELEVATIONS	AS SHOWN
0049	ARCHITECTURAL FOUNDATION ROOF WALLS	AS SHOWN
0050	ARCHITECTURAL FOUNDATION ROOF FLOOR PLAN	AS SHOWN
0051	ARCHITECTURAL FOUNDATION ROOF ELEVATIONS	AS SHOWN
0052	ARCHITECTURAL FOUNDATION ROOF WALLS	AS SHOWN
0053	ARCHITECTURAL FOUNDATION ROOF FLOOR PLAN	AS SHOWN
0054	ARCHITECTURAL FOUNDATION ROOF ELEVATIONS	AS SHOWN
0055	ARCHITECTURAL FOUNDATION ROOF WALLS	AS SHOWN
0056	ARCHITECTURAL FOUNDATION ROOF FLOOR PLAN	AS SHOWN
0057	ARCHITECTURAL FOUNDATION ROOF ELEVATIONS	AS SHOWN
0058	ARCHITECTURAL FOUNDATION ROOF WALLS	AS SHOWN
0059	ARCHITECTURAL FOUNDATION ROOF FLOOR PLAN	AS SHOWN
0060	ARCHITECTURAL FOUNDATION ROOF ELEVATIONS	AS SHOWN
0061	ARCHITECTURAL FOUNDATION ROOF WALLS	AS SHOWN
0062	ARCHITECTURAL FOUNDATION ROOF FLOOR PLAN	AS SHOWN
0063	ARCHITECTURAL FOUNDATION ROOF ELEVATIONS	AS SHOWN
0064	ARCHITECTURAL FOUNDATION ROOF WALLS	AS SHOWN
0065	ARCHITECTURAL FOUNDATION ROOF FLOOR PLAN	AS SHOWN
0066	ARCHITECTURAL FOUNDATION ROOF ELEVATIONS	AS SHOWN
0067	ARCHITECTURAL FOUNDATION ROOF WALLS	AS SHOWN
0068	ARCHITECTURAL FOUNDATION ROOF FLOOR PLAN	AS SHOWN
0069	ARCHITECTURAL FOUNDATION ROOF ELEVATIONS	AS SHOWN
0070	ARCHITECTURAL FOUNDATION ROOF WALLS	AS SHOWN
0071	ARCHITECTURAL FOUNDATION ROOF FLOOR PLAN	AS SHOWN
0072	ARCHITECTURAL FOUNDATION ROOF ELEVATIONS	AS SHOWN
0073	ARCHITECTURAL FOUNDATION ROOF WALLS	AS SHOWN
0074	ARCHITECTURAL FOUNDATION ROOF FLOOR PLAN	AS SHOWN
0075	ARCHITECTURAL FOUNDATION ROOF ELEVATIONS	AS SHOWN
0076	ARCHITECTURAL FOUNDATION ROOF WALLS	AS SHOWN
0077	ARCHITECTURAL FOUNDATION ROOF FLOOR PLAN	AS SHOWN
0078	ARCHITECTURAL FOUNDATION ROOF ELEVATIONS	AS SHOWN
0079	ARCHITECTURAL FOUNDATION ROOF WALLS	AS SHOWN
0080	ARCHITECTURAL FOUNDATION ROOF FLOOR PLAN	AS SHOWN
0081	ARCHITECTURAL FOUNDATION ROOF ELEVATIONS	AS SHOWN
0082	ARCHITECTURAL FOUNDATION ROOF WALLS	AS SHOWN
0083	ARCHITECTURAL FOUNDATION ROOF FLOOR PLAN	AS SHOWN
0084	ARCHITECTURAL FOUNDATION ROOF ELEVATIONS	AS SHOWN
0085	ARCHITECTURAL FOUNDATION ROOF WALLS	AS SHOWN
0086	ARCHITECTURAL FOUNDATION ROOF FLOOR PLAN	AS SHOWN
0087	ARCHITECTURAL FOUNDATION ROOF ELEVATIONS	AS SHOWN
0088	ARCHITECTURAL FOUNDATION ROOF WALLS	AS SHOWN
0089	ARCHITECTURAL FOUNDATION ROOF FLOOR PLAN	AS SHOWN
0090	ARCHITECTURAL FOUNDATION ROOF ELEVATIONS	AS SHOWN
0091	ARCHITECTURAL FOUNDATION ROOF WALLS	AS SHOWN
0092	ARCHITECTURAL FOUNDATION ROOF FLOOR PLAN	AS SHOWN
0093	ARCHITECTURAL FOUNDATION ROOF ELEVATIONS	AS SHOWN
0094	ARCHITECTURAL FOUNDATION ROOF WALLS	AS SHOWN
0095	ARCHITECTURAL FOUNDATION ROOF FLOOR PLAN	AS SHOWN
0096	ARCHITECTURAL FOUNDATION ROOF ELEVATIONS	AS SHOWN
0097	ARCHITECTURAL FOUNDATION ROOF WALLS	AS SHOWN
0098	ARCHITECTURAL FOUNDATION ROOF FLOOR PLAN	AS SHOWN
0099	ARCHITECTURAL FOUNDATION ROOF ELEVATIONS	AS SHOWN
0100	ARCHITECTURAL FOUNDATION ROOF WALLS	AS SHOWN

10/11/16 10:00 AM

Copyright © 2015  
 ALL RIGHTS RESERVED. THIS DOCUMENT IS THE PROPERTY OF NICHOLS MELTZBURG ROSSETTO ARCHITECTS + ENGINEERS. IT IS TO BE USED ONLY FOR THE PROJECT AND SITE SPECIFICALLY IDENTIFIED HEREIN.



**NICHOLS MELTZBURG ROSSETTO**  
 ARCHITECTS + ENGINEERS  
 556 MAIN STREET, SUITE 300  
 CHICO, CA 95926  
 530 (916) 838-8908 FAX  
 INFO@NMRARCHITECTS.COM  
 CONSULTANTS

DATE: 08/11/2015

PROJECT NAME  
**WINERY EXPANSION FOR**



CLIENT  
**ROBERT BIALE VINEYARDS**  
 4028 BIG RANCH RD.  
 NAPA, CA

PROJECT TYPE  
**OVERALL SITE PLAN / WINERY DEVELOPMENT SITE PLAN**

ISSUING STATUS  
**USE PERMIT MODIFICATION**

DESIGNED BY  
**JRELL DOCUMENT # 1501\_0029**

DRAWN BY  
**SAAG**

CHECKED BY  
 Date Drawn 2015-12-01  
 Scale AS NOTED


JOB NO. 15-041  
 SHEET NO. **A010**

- LEGEND**
- INDICATES PROPOSED NEW ASPHALT CONCRETE PAVING
  - INDICATES PROPOSED NEW CONCRETE SLAB WORK
  - INDICATES PROPOSED NEW RECONSTRUCTED EXISTING PEDESTRIAN PATH
  - INDICATES EXISTING VINEYARD ROWS
  - INDICATES AREA OF NEW LEVY FLOOD PLAIN FLOOD PLUM APPROXIMATELY 1/2 FEET NORTH OF EXISTING FLOOD PLUM
  - MAXIMUM SLOPE IN PATH SEGMENT FROM DRIVE TO BUILDING
  - ELECTRICAL LINE
  - INDICATES LINES OF FEMA 100 LEVY FLOOD PLAIN FLOOD PLUM APPROXIMATELY 1/2 FEET NORTH OF EXISTING FLOOD PLUM
  - INDICATES PROPERTY LINE OR WELL SETBACK
  - INDICATES DISTANCE BETWEEN PROPERTY CORNERS
  - INDICATES EXISTING CONTOUR NO. AND DATUM BENCHMARK
  - INDICATES STORMWATER CONTROL PLANS FOR SLOPE
  - INDICATES STORMWATER CONTROL PLANS FOR SLOPE
  - INDICATES EXISTING FIRE HYDRANT


- SHEET NOTES**
- EXISTING ASPHALT CONCRETE DRIVEWAY TO BE DEMOLISHED
  - NEW NAPA COUNTY 6:11 DRIVEWAY TURNOUT
  - NAPA COUNTY 6:11 HAMMERSHEAD FIVE NEW PARALLEL PARKING SPACE AND LOADING
  - ZONE THROUGH GOODING GRADE PAVEMENT OVER LOW PARKING AREA WITH 4' CONFORMING TO NAPA COUNTY ROAD AND STREET DIMENSIONS DETAIL (N.A.)
  - VIP TASTING AREA, WINEMOUNT AND TAMP TO BE DEMOLISHED
  - LIMITS OF 100-YEAR FLOOD PLAIN
  - CLASS A AGGREGATE BASE EMPLOYEE PARKING AREA
  - APPROVED UNDER NAPA COUNTY PERMIT NO. W0370201. SEE SHEET C200 STORMWATER CONTROL PLAN.
  - APPROVED UNDER NAPA COUNTY PERMIT NO. W0320903
  - SOLID WASTE COLLECTION, GARBAGE, RECYCLABLES AND GREEN WASTE TO BE DEMOLISHED

NO.	DESCRIPTION	DATE	BY
1	ISSUED FOR PERMIT	08/11/2015	JRELL
2	ISSUED FOR PERMIT MODIFICATION	08/11/2015	JRELL
3	ISSUED FOR PERMIT MODIFICATION	08/11/2015	JRELL
4	ISSUED FOR PERMIT MODIFICATION	08/11/2015	JRELL
5	ISSUED FOR PERMIT MODIFICATION	08/11/2015	JRELL
6	ISSUED FOR PERMIT MODIFICATION	08/11/2015	JRELL
7	ISSUED FOR PERMIT MODIFICATION	08/11/2015	JRELL
8	ISSUED FOR PERMIT MODIFICATION	08/11/2015	JRELL
9	ISSUED FOR PERMIT MODIFICATION	08/11/2015	JRELL
10	ISSUED FOR PERMIT MODIFICATION	08/11/2015	JRELL
11	ISSUED FOR PERMIT MODIFICATION	08/11/2015	JRELL

NO.	DESCRIPTION	DATE	BY
1	ISSUED FOR PERMIT MODIFICATION	08/11/2015	JRELL
2	ISSUED FOR PERMIT MODIFICATION	08/11/2015	JRELL
3	ISSUED FOR PERMIT MODIFICATION	08/11/2015	JRELL
4	ISSUED FOR PERMIT MODIFICATION	08/11/2015	JRELL
5	ISSUED FOR PERMIT MODIFICATION	08/11/2015	JRELL
6	ISSUED FOR PERMIT MODIFICATION	08/11/2015	JRELL
7	ISSUED FOR PERMIT MODIFICATION	08/11/2015	JRELL
8	ISSUED FOR PERMIT MODIFICATION	08/11/2015	JRELL
9	ISSUED FOR PERMIT MODIFICATION	08/11/2015	JRELL
10	ISSUED FOR PERMIT MODIFICATION	08/11/2015	JRELL
11	ISSUED FOR PERMIT MODIFICATION	08/11/2015	JRELL

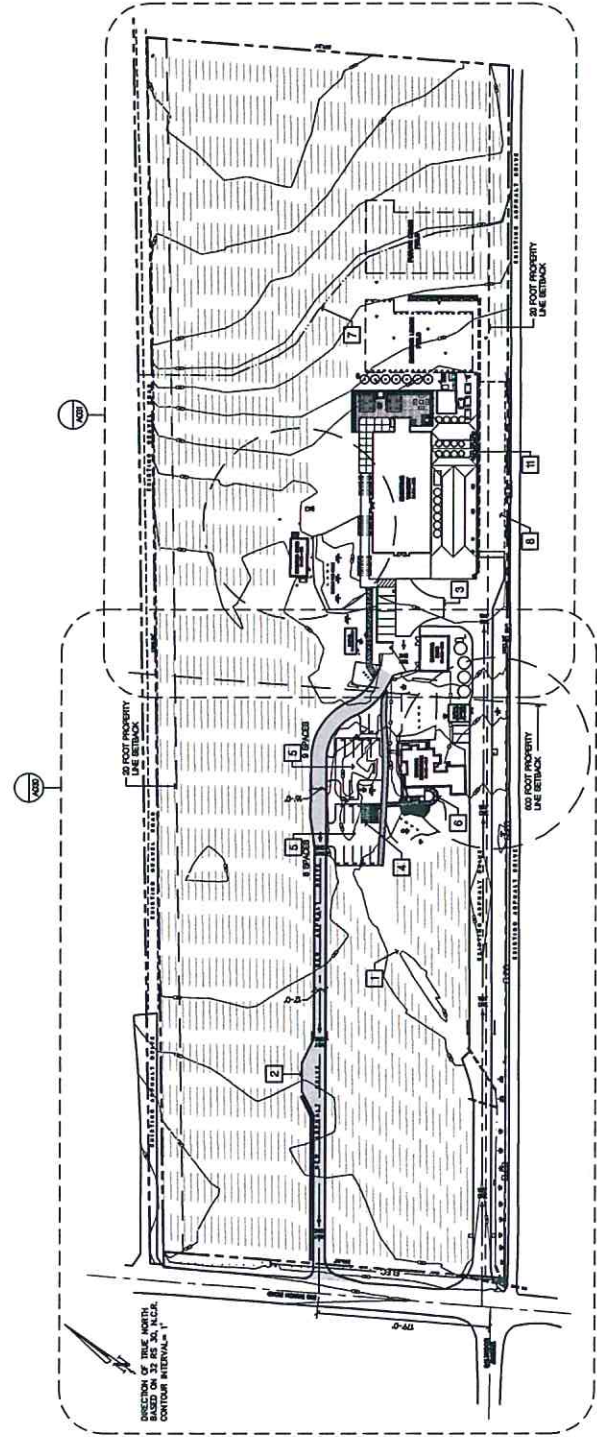

**OVERALL SITE PLAN**  
 PRINTED FULL SIZE: 1/8"=1'-0"

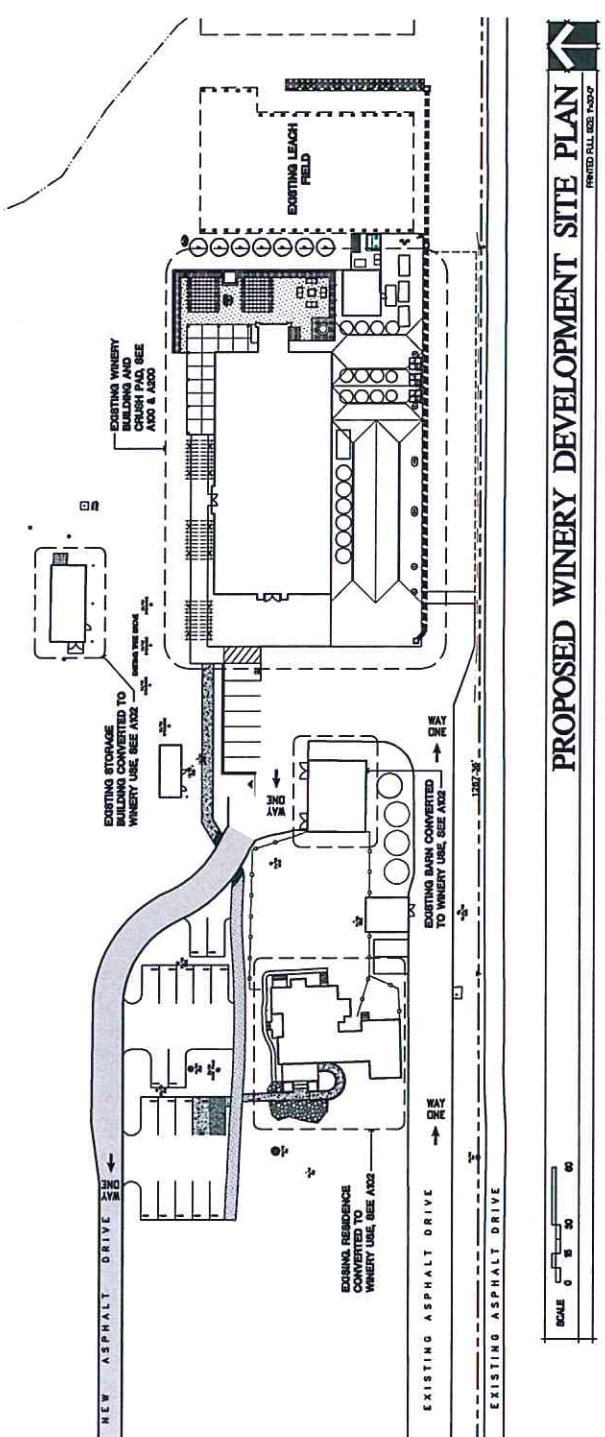

**PROPOSED WINERY DEVELOPMENT SITE PLAN**  
 PRINTED FULL SIZE: 1/8"=1'-0"

1/8"=1'-0" Scale  
 Project: Winery Expansion - Robert Biale Vineyards  
 Date: 08/11/2015  
 Author: JRELL  
 Checker: SAAG

**COURT © 2018**  
ALL RIGHTS RESERVED. THIS DOCUMENT IS THE PROPERTY OF NICHOLS MEBURG ROSETTO ARCHITECTS - ENGINEERS. NO PART OF THIS DOCUMENT MAY BE REPRODUCED OR TRANSMITTED IN ANY FORM OR BY ANY MEANS, ELECTRONIC OR MECHANICAL, INCLUDING PHOTOCOPYING, RECORDING, OR BY ANY INFORMATION STORAGE AND RETRIEVAL SYSTEM, WITHOUT THE WRITTEN PERMISSION OF NICHOLS MEBURG ROSETTO ARCHITECTS - ENGINEERS.

**NICHOLS  
MEBURG  
ROSETTO**  
ARCHITECTS - ENGINEERS  
595 MAIN STREET, SUITE 300  
CHICO, CA 95926  
909.291.0001 FAX  
NEW@nicholsmeburg.com  
CONSULTANTS

**PROJECT NAME**  
WINERY  
EXPANSION  
FOR



**ROBERT BIALE  
VINEYARDS**  
409 BIG RANCH RD.  
HOLY, CA

**SECRET TITLE**  
PARTIAL  
SITE PLAN

**BUILDING STATUS**  
USE PERMIT  
MODIFICATION

ISSUANCE


Drawn By	SAG
Checked By	
Date Drawn	2018-12-01
Scale	AS NOTED
Job No.	16-0491
Sheet No.	

**A030**

- LEGEND**
- [Symbol] INDICATES PROPOSED NEW ASPHALT CONCRETE PAVING
  - [Symbol] INDICATES PROPOSED NEW CONCRETE FLAT WORK
  - [Symbol] INDICATES PROPOSED NEW DISCOMBATED CONC. PEDESTRIAN PATH
  - [Symbol] INDICATES EXISTING WINE/NO FLOWS
  - [Symbol] INDICATES AREA OF NEW TRAVEL FROM BUILDING TO DISABLED PARKING TO BUILDING
  - [Symbol] MAXIMUM SLOPE IN PATH SEGMENT TO BE CONSIDERED
  - [Symbol] INDICATES LIMITS OF FEMA 100 YEAR FLOOD PLAIN (FLOOD PLAIN APPROXIMATELY 21 FEET NORTH OF EXISTING PROPERTY LINE)
  - [Symbol] INDICATES PROPERTY LINE OR WELL SETBACK
  - [Symbol] INDICATES PROPERTY LINE OR DISTANCE BETWEEN PROPERTY CORNERS
  - [Symbol] INDICATES SCOOTING CONTOUR FOR WIND ROADS
  - [Symbol] INDICATES DRAINAGE SWALE. SEE STORMWATER CONTROL PLANS FOR SLOPE
  - [Symbol] INDICATES EXISTING FIVE FOOT ANT

**SHEET NOTES**

- EXISTING ASPHALT CONCRETE DRIVEWAY TO BE DISCONTINUED
- NEW ASPHALT C-11 DRIVEWAY TURNOUT
- MAP COUNTY-G11 HAMMERHEAD FIRE ZONE
- NEW DISABLED PARKING SPACE AND LOADING DOCK
- OVERFLOW PARKING AREA WITH 4" CONFORMING TO NAPA COUNTY ROAD AND STREET STANDARDS DETAIL P1
- NEW WINE TASTING AREA AND TAMP TO WINE TASTING AREA
- LIMITS OF 100-YEAR FLOOD PLAIN PARKING AREA
- CLASS 4 AGGREGATE BASE EMPLOYEE PARKING AREA
- APPROPRIATE LINES FOR NAPA COUNTY PERMIT NO. W20201. SEE SHEET C029 STORMWATER CONTROL PLAN
- UNDER NAPA COUNTY PERMIT NO. W20201. SEE SHEET C029 STORMWATER CONTROL PLAN
- SOLID WASTE COLLECTION, GARBAGE, RECYCLABLES AND GREEN WASTE

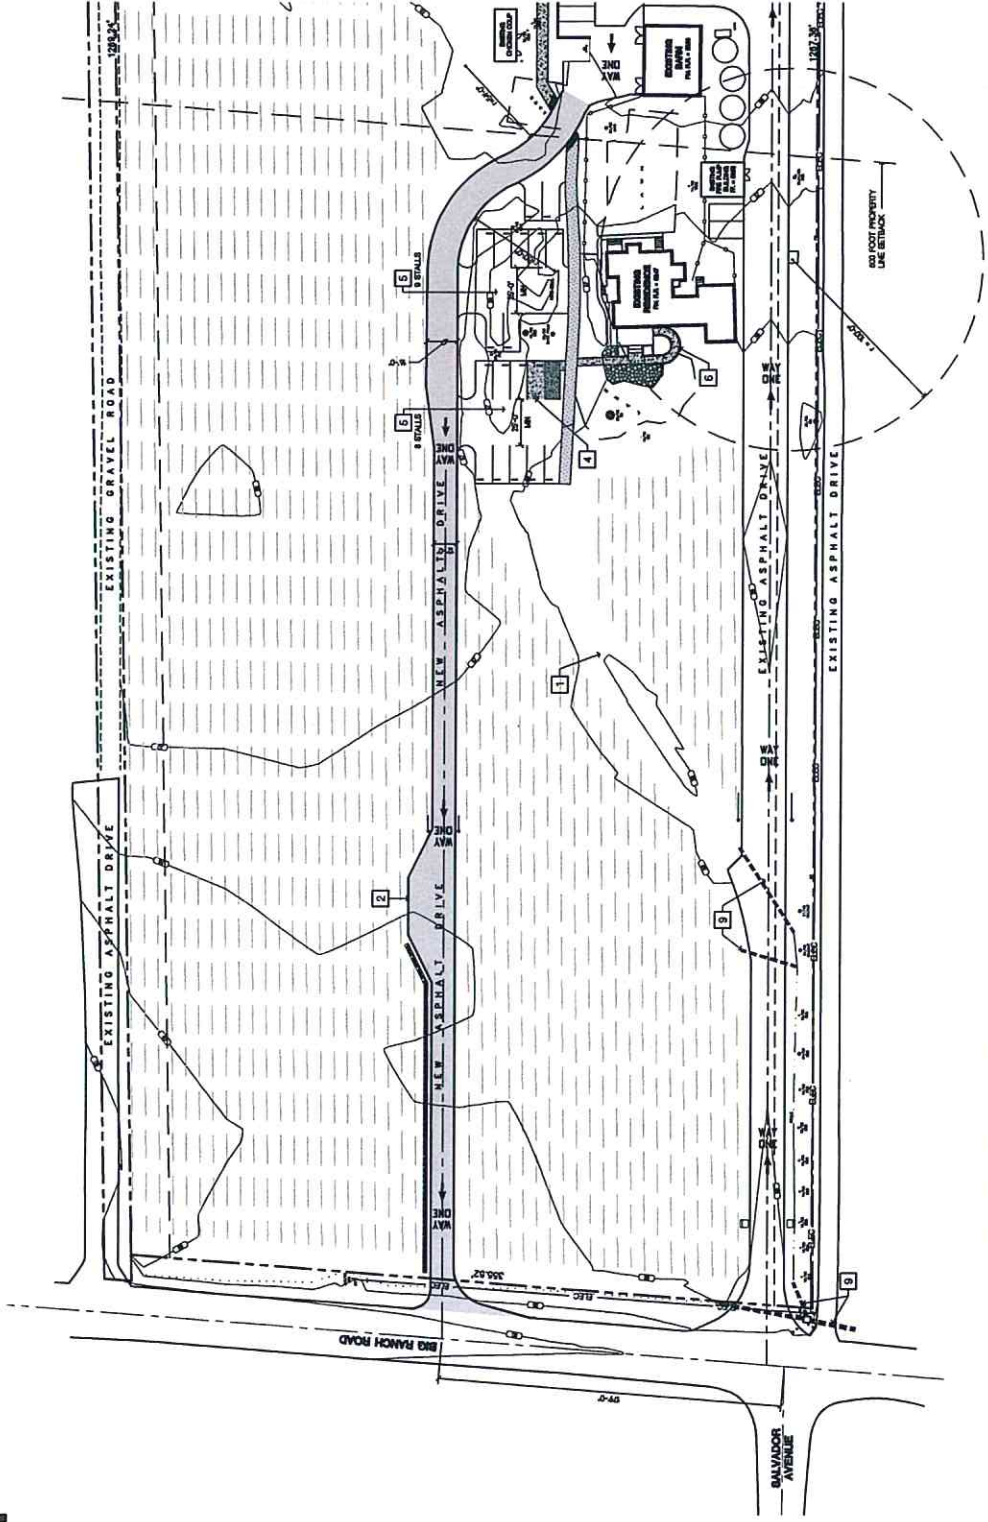

**PARTIAL SITE PLAN - WEST**  
PRINTED FULL SIZE A030F



**COURT © 2015**  
 THE ARCHITECTS AND ENGINEERS OF NICHOLS MERRITT ROSSBETTO ARCHITECTS - ENGINEERS  
 595 MAIN STREET, SUITE 300  
 SUITE 300 595 MAIN STREET SUITE 300  
 NEW PALM BEACH, FLORIDA 33411  
 TEL: 561-844-9800 FAX: 561-844-9801  
 WWW.NMRARCHITECTS.COM

**NICHOLS  
 MERRITT  
 ROSSBETTO**  
 ARCHITECTS - ENGINEERS

595 MAIN STREET, SUITE 300  
 SUITE 300 595 MAIN STREET SUITE 300  
 NEW PALM BEACH, FLORIDA 33411  
 TEL: 561-844-9800 FAX: 561-844-9801  
 WWW.NMRARCHITECTS.COM

**CONSULTANTS**

- LEGEND**
- INDICATES PROPOSED NEW ASPHALT CONCRETE PAVING
  - INDICATES PROPOSED NEW CONCRETE PLANT WORK
  - INDICATES PROPOSED NEW PEDESTRIAN PATH
  - INDICATES EXISTING VINEYARD ROWS
  - INDICATES AREA OF NEW TRIMMED DOMES ADA ACCESSIBLE ROUTES OF TRAVEL FROM DISABLED PARKING TO BUILDING
  - MAXIMUM ELEVATION IN PATH SEGMENT
  - MINIMUM ELEVATION IN PATH SEGMENT
  - ELECTRICAL LINE
  - INDICATES LIMITS OF FEMA 100 YEAR FLOOD PLANT FLOOD PLAIN APPROXIMATELY 51 FEET NORTH
  - INDICATES VERTICAL CURVA LINE
  - WELL NETWORK
  - INDICATES PROPERTY LINE
  - DISTANCE BETWEEN PROPERTY CORNERS
  - INDICATES EXISTING CONTOUR
  - INDICATES PROPERTY BOUNDARY
  - INDICATES EXISTING FIRE INTERMAT
  - INDICATES EXISTING FIRE INTERMAT
  - INDICATES EXISTING FIRE INTERMAT
  - INDICATES EXISTING FIRE INTERMAT

**SHEET NOTES**

- 1 EXISTING ASPHALT CONCRETE DRIVEWAY TO BE DEMOLISHED
- 2 NEW NAPA COUNTY C-11 DRIVEWAY TURNOUT
- 3 NAPA COUNTY C-11 HAMMERHEAD FIRE
- 4 NEW GRASSED PARKING SPACE AND LOADING ZONE
- 5 NEW 30' X 30' EXISTING GRASS PATTER OVEYFLOW PARKING AREA WITH "E" CONFORMING TO NAPA COUNTY ROAD AND STREET STANDARDS DETAIL #1
- 6 VINYL FLOORING AND MOP TO VIT TASTING AREA
- 7 LIMITS OF 100-YEAR FLOOD PLAIN
- 8 CLASS 4 AGGREGATE BASE EMPLOYEE PARKING AREA
- 9 CLASS 4 AGGREGATE BASE EMPLOYEE PARKING AREA
- 10 CLASS 4 AGGREGATE BASE EMPLOYEE PARKING AREA
- 11 CLASS 4 AGGREGATE BASE EMPLOYEE PARKING AREA
- 12 CLASS 4 AGGREGATE BASE EMPLOYEE PARKING AREA

**LICENSE STAMPS**


**PROJECT TITLE**  
**WINERY EXPANSION FOR**  
**ROBERT BIALE VINEYARDS**  
 4038 BIG BUNCH RD.  
 NAPA, CA

**SECRET TITLE**  
**PARTIAL SITE PLAN**

**ISSUED STATE OF CALIFORNIA**  
**USE PERMIT MODIFICATION**

PREPARED BY: [Signature]  
 DATE: 12/15/15

Drawn By	SAG
Checked By	
Date Drawn	2015-12-15
Scale	AS NOTED
Job No.	15-5491
Sheet No.	A031

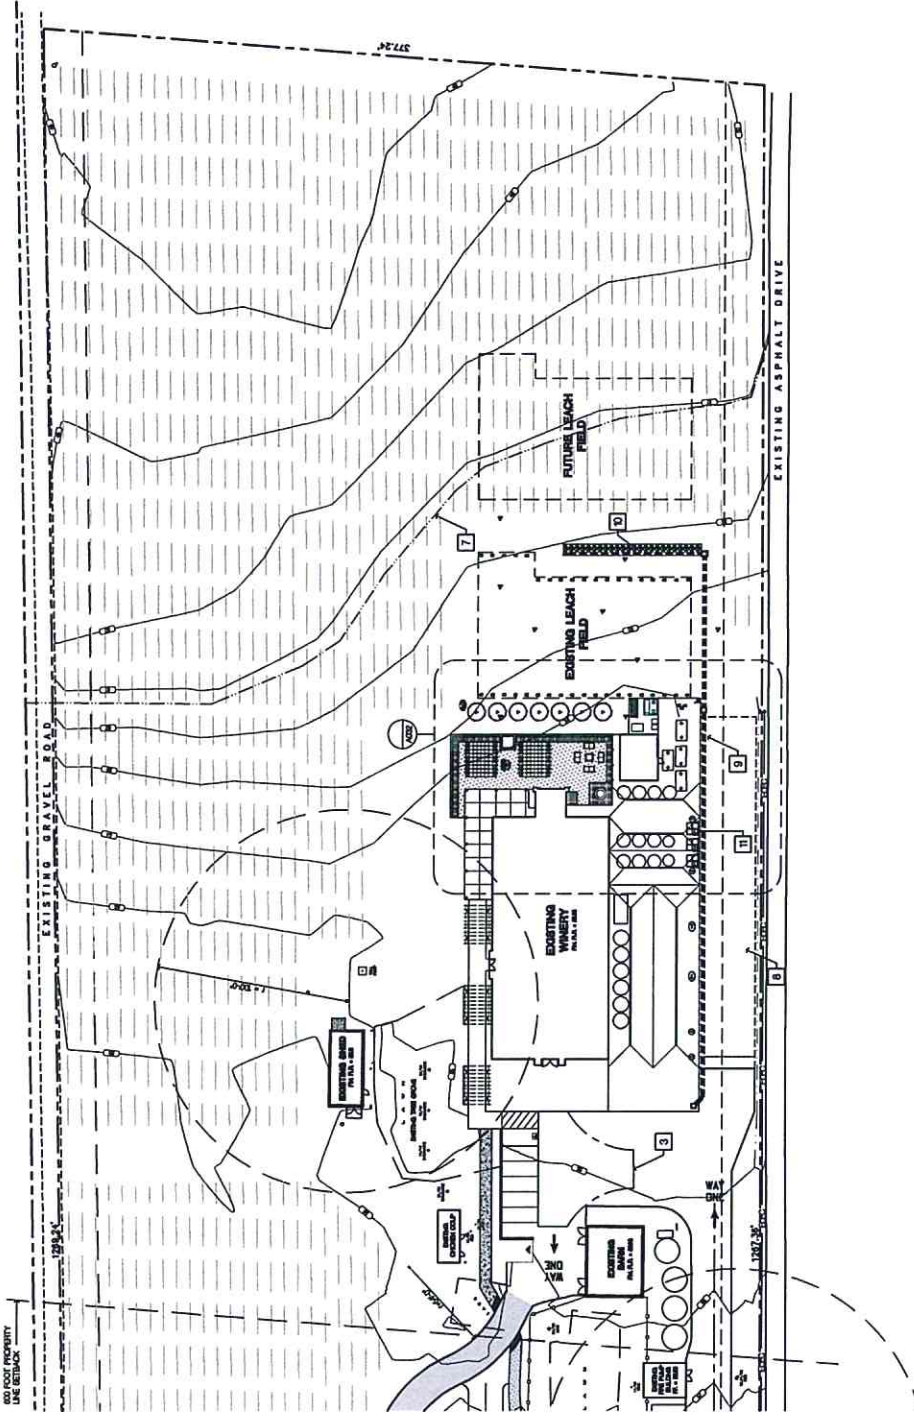

**PARTIAL SITE PLAN - EAST**  
 PRINTED FULL SIZE 1/8"=1'-0"

SCALE 0 15 30 45

Copyright © 2018  
 All rights reserved. No part of this document may be reproduced, stored in a retrieval system, or transmitted in any form or by any means, electronic, mechanical, photocopying, recording, or by any information storage and retrieval system, without the prior written permission of the copyright owner.



**NICHOLS  
 MERG  
 ROSSETTO**  
 ARCHITECTS + ENGINEERS  
 555 MAIN STREET, SUITE 300  
 5300 8TH AVE, SUITE 8000  
 1671/WWW.NMRARCH.COM  
 CONSULTANTS

LICENSE STAMPS

PROJECT NAME  
**WINERY  
 EXPANSION  
 FOR**



**ROBERT BIALE  
 VINEYARDS**  
 4038 BIG BUNCH RD.  
 NAPA, CA

SECRET TITLE  
 PARTIAL  
 SITE PLAN


REVISIONS  
 USE PERMIT  
 MODIFICATION

Revised By: [Name]  
 Date: [Date]  
 Rev. 1.0: [Description]

Drawn By: [Name]  
 Checked By: [Name]  
 Date Drawn: 2018-12-01  
 Scale: AS NOTED  
 Job No.: 18-041  
 SHEET No. A032

- LEGEND**
- INDICATES PROPOSED NEW ASPHALT CONCRETE PAVING
  - INDICATES PROPOSED NEW CONCRETE PAVEMENT
  - INDICATES PROPOSED NEW DECOMPOSED GRANITE PEDESTAL PATH
  - INDICATES EXISTING VINEYARD ROWS
  - INDICATES AREA OF NEW DETECTABLE WALKWAY (ACCESSIBLE ROUTES OF TRAVEL FROM DISABLED PARKING TO BUILDING)
  - MAXIMUM SLOPE IN PATH SEGMENT
  - ELECTRICAL LINE
  - INDICATES LIMITS OF FEMA 100 FLOOD PLAIN (ELEVATION APPROXIMATELY 51.0 FEET NORTH OF THE DETECTABLE WALKWAY)
  - INDICATES PROPERTY LINE OR WELL SETBACK
  - INDICATES PROPERTY LINE
  - DISTANCE BETWEEN PROPERTY CORNERS
  - INDICATES EXISTING CONTOUR (FOR SPOT ELEVATIONS ONLY)
  - INDICATES EXISTING CONTOUR (FOR SPOT ELEVATIONS ONLY)
  - INDICATES DRAINAGE SWALE (SEE STORMWATER CONTROL PLANS)
  - INDICATES FLOOD SWALE (SEE STORMWATER CONTROL PLANS FOR SIZE AND SLOPE)
  - INDICATES EXISTING FIRE RETARDANT

- SHEET NOTES**
- EXISTING ASPHALT CONCRETE DRIVEWAY TO BE CONCRETE
  - NEW NAPA COUNTY 6-11 DRIVEWAY TURNOUT
  - NEW NAPA COUNTY 6-11 DRIVEWAY TURNOUT APPROXIMATE TURNAROUND
  - NEW UNPAVED PARKING SPACE AND LOADING
  - NEW PREVIOUS GEORDED GRASS PAPER OVER LOW PARKING AREA WITH 4" CONCRETE CURB AND 18" GRANULAR FILL CONFORMING TO NAPA COUNTY ROAD AND SIDEWALK SPECIFICATIONS AND RAMP TO NEW ACCESSIBLE WALKWAY AND RAMP TO VP PAVING AREA
  - LIMITS OF 100-YEAR FLOOD PLAIN
  - CLASS A AGGREGATE BASE EMPLOYE
  - NEW 18" DIA. STORMWATER PIPES APPROVED UNDER NAPA COUNTY PERMIT NO. W030001. SEE SHEET FOR DETAILS.
  - STORMWATER COLLECTION, GARBAGE, RECYCLABLES AND GREEN WASTE

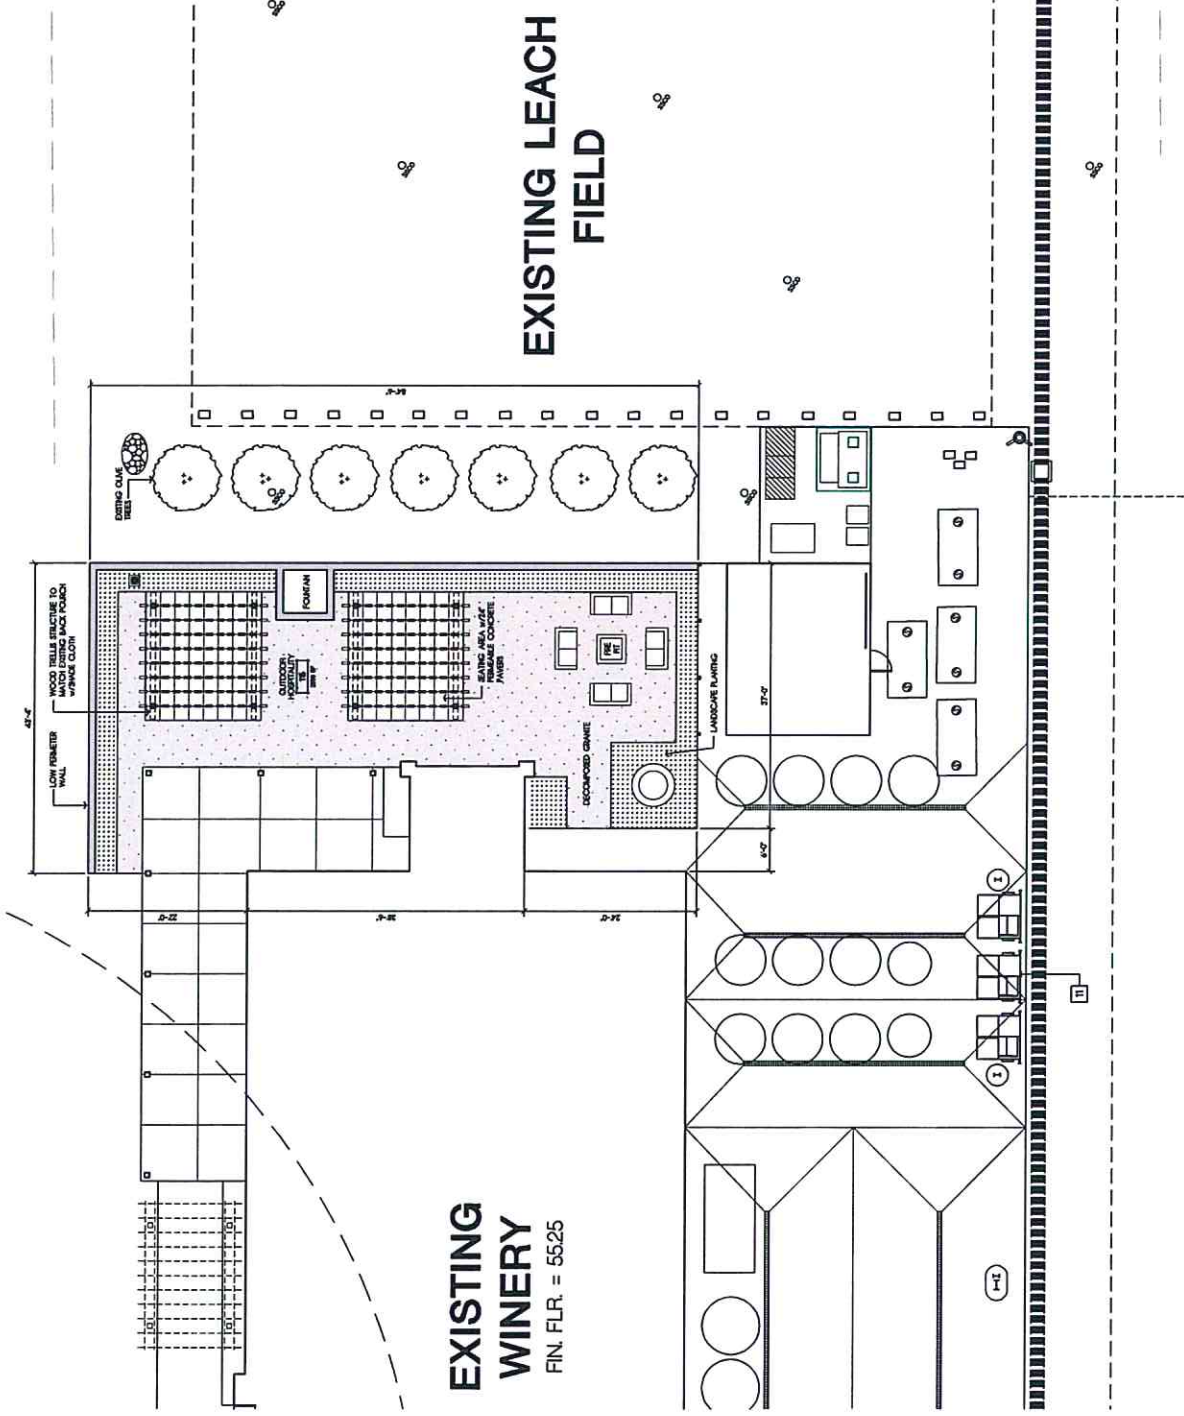

**EXISTING  
 WINERY**  
 FIN. FLR. = 55.25

**PARTIAL SITE PLAN - BACK PORCH EXPANSION**  
 SCALE 0' 1" 2" 4" 8" 16"  
 PRINTED FULL SIZE 18" x 24"

# LEGEND



INDICATES EXISTING WINERY DEVELOPMENT AREA - 17,345 S.F.

CONTRACT © 2018  
 4255 W. 14TH AVENUE, SUITE 100, DENVER, CO 80202  
 TEL: 303.733.8800 FAX: 303.733.8801  
 WWW.NICHOLSMEIERGROSSI.COM

**NICHOLS MEIERGROSSI**  
 ARCHITECTS + ENGINEERS  
 555 MAIN STREET, SUITE 300  
 DENVER, CO 80202  
 500 5TH AVE, SUITE 800, DENVER, CO 80202  
 TEL: 303.733.8800 FAX: 303.733.8801  
 WWW.NICHOLSMEIERGROSSI.COM

CONSULTANTS

LICENSE STAMPS

PROJECT NAME  
**WINERY EXPANSION FOR**  
**ROBERT BIALE VINEYARDS**  
 425 W. 14TH RD.  
 DENVER, CO


SHEET TITLE  
**WINERY FIRST FLOOR PLAN**

DRAWING STATUS  
**USE PERMIT MODIFICATION**

REVISIONS  
 Sym. Description By Date  
 REV.1. G.S. DOMINGUEZ S.M. 02/25/18

Drawn By	SAG
Checked By	
Date Drawn	2018-12-01
Scale	AS NOTED
Job No.	16-0491

SHEET No.  
**A100**

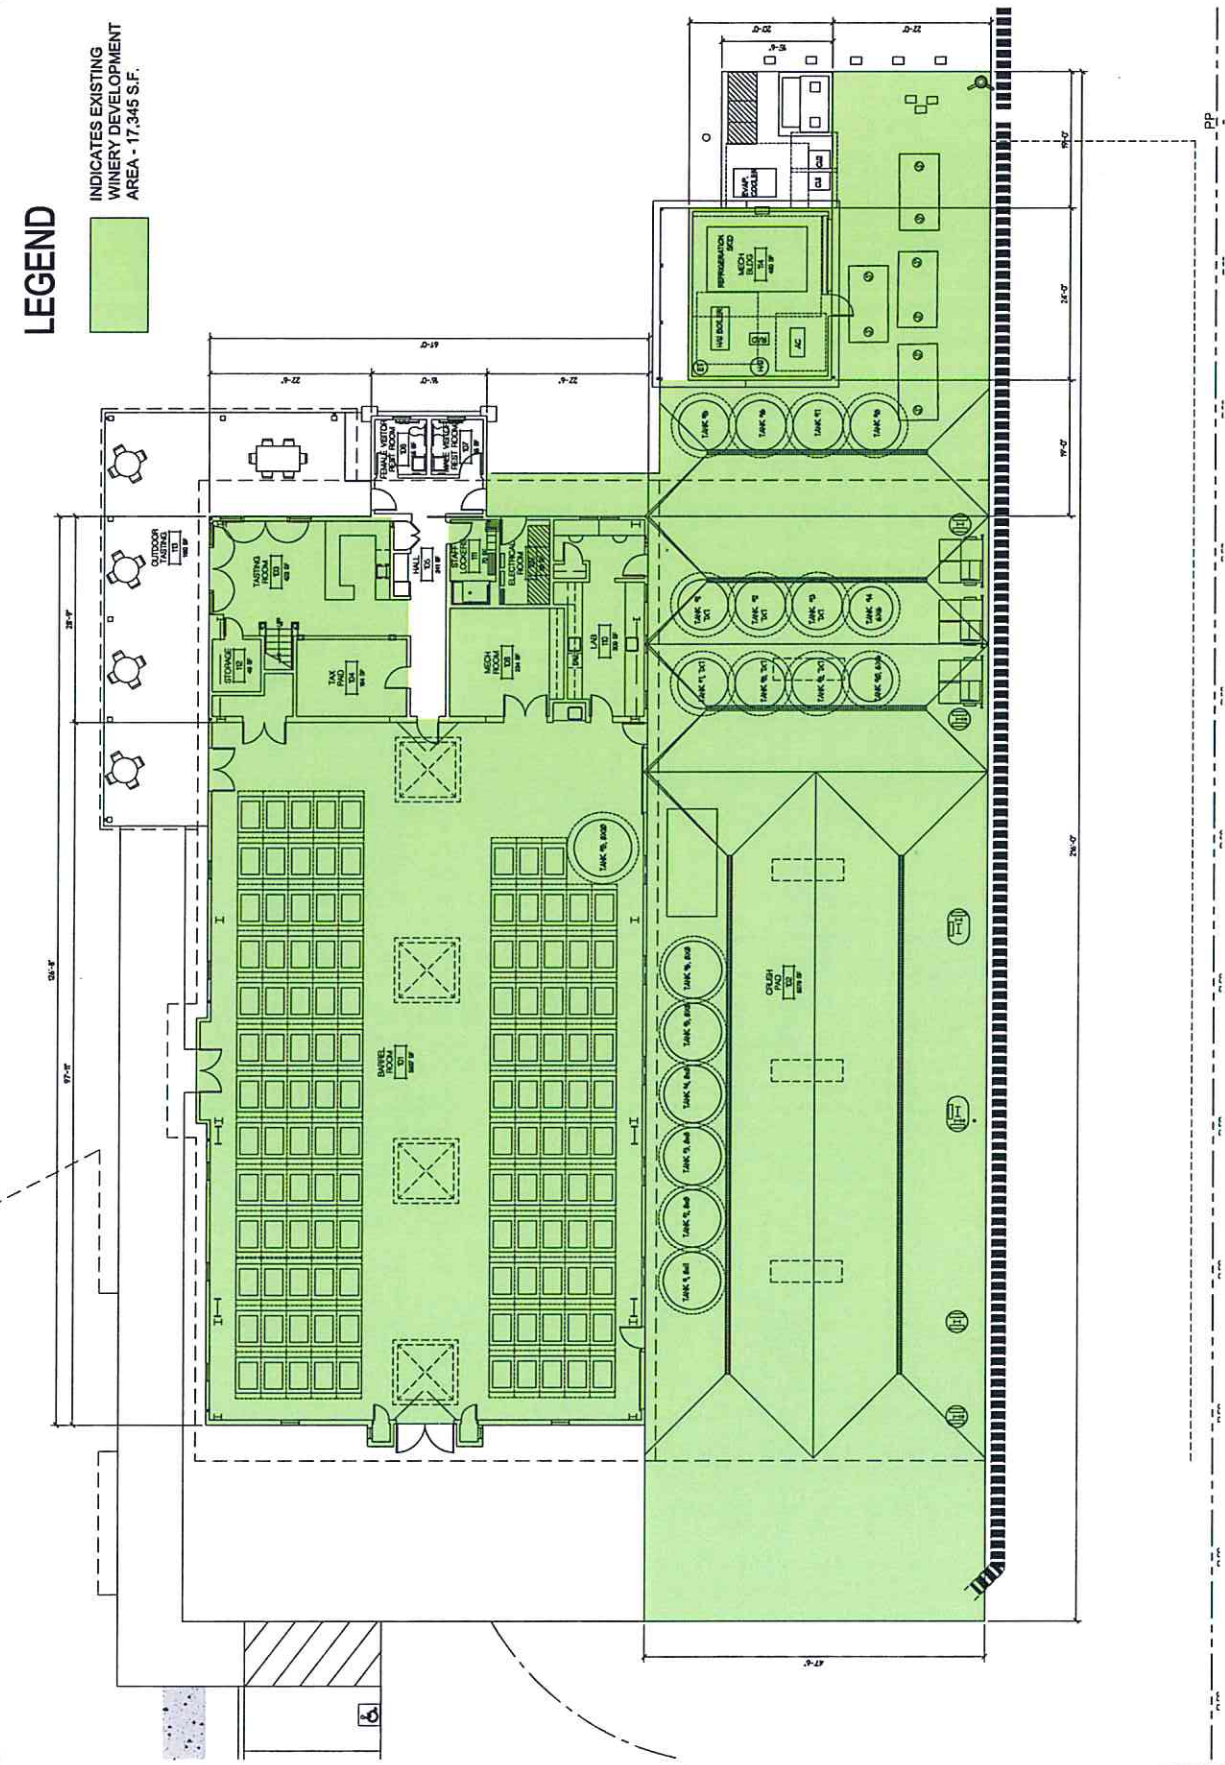


SCALE 0' 1" = 10'

PRINTED FULL SIZE 18" X 24"

**EXISTING WINERY FIRST FLOOR PLAN**

12/1/2018 10:54 AM  
 P:\16-0491\16-0491-01\16-0491-01-01\16-0491-01-01-01.dwg  
 16-0491-01-01-01.dwg  
 12/1/2018 10:54 AM  
 P:\16-0491\16-0491-01\16-0491-01-01\16-0491-01-01-01.dwg  
 16-0491-01-01-01.dwg

Copyright © 2018  
 The information contained herein is the property of Nichols Merger Rossetto Architects + Engineers and is to be used only for the project and site specifically identified herein. No part of this document may be reproduced or transmitted in any form or by any means electronic or mechanical, including photocopying, recording, or by any information storage and retrieval system, without the prior written permission of Nichols Merger Rossetto Architects + Engineers.

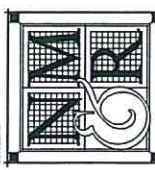

**NICHOLS  
 MERGER  
 ROSSETTO**  
 ARCHITECTS + ENGINEERS  
 555 VAN STREET, SUITE 300  
 5000 18th AVE, SUITE 300  
 94708 SAN FRANCISCO, CA  
 415.774.8800 FAX  
 415.774.8801  
 www.nmrarch.com  
 CONSULTANTS

LICENSE STAMPS

PROJECT NAME  
**WINERY  
 EXPANSION  
 FOR**



**ROBERT BIALE  
 VINEYARDS**  
 408 BIRCHBACH RD.  
 SUTTER, CA

SHEET TITLE  
**WINERY FIRST  
 FLOOR PLAN**

DRAWING STATUS  
**USE PERMIT  
 MODIFICATION**

REVISIONS  
 Sym. Description By Date  
 REV.1 20.08.2018 J.M.L. 2018.08.20

Drawn By: SAG  
 Checked By: [blank]  
 Date Drawn: 2018.08.20  
 Scale: AS NOTED  
 Job No.: 18-0481  
 SHEET No.: [blank]


**A101**

**LEGEND**

- INDICATES EXISTING WINERY PRODUCTION FACILITIES
- INDICATES EXISTING WINERY ACCESSORY USE AREA
- INDICATES PROPOSED NEW WINERY PRODUCTION FACILITY
- INDICATES PROPOSED NEW WINERY ACCESSORY USE AREA

BUILDING	PRODUCT USE (S.F.)	ACCESS USE (S.F.)	TOTAL AREA (S.F.)	NOTES
WINERY	16,183	127	16,310	EXISTING USE - NO CHANGES
1st FLR	58	10,255	10,313	
2nd FLR	58	10,255	10,313	
TOTAL	116	20,510	20,626	
MECH. PLANT	400		400	
EXISTING RESIDENCE	2,151		2,151	21ST WHOLLY CONVERTED TO WHOLLY WINERY USE
EXIST. BARN	1,624		1,624	WHOLLY CONVERTED TO WHOLLY WINERY USE
1st FLR	473		473	
LOFT	1,151		1,151	
TOTAL	3,275		3,275	
EXISTING STORAGE BLDG.	123	599	728	728 WHOLLY CONVERTED TO WHOLLY WINERY USE
TOTAL ALL BLDGS.	18,172	5,502	23,674	

PROPOSED PERCENT ACCESSORY USE - 23.9%

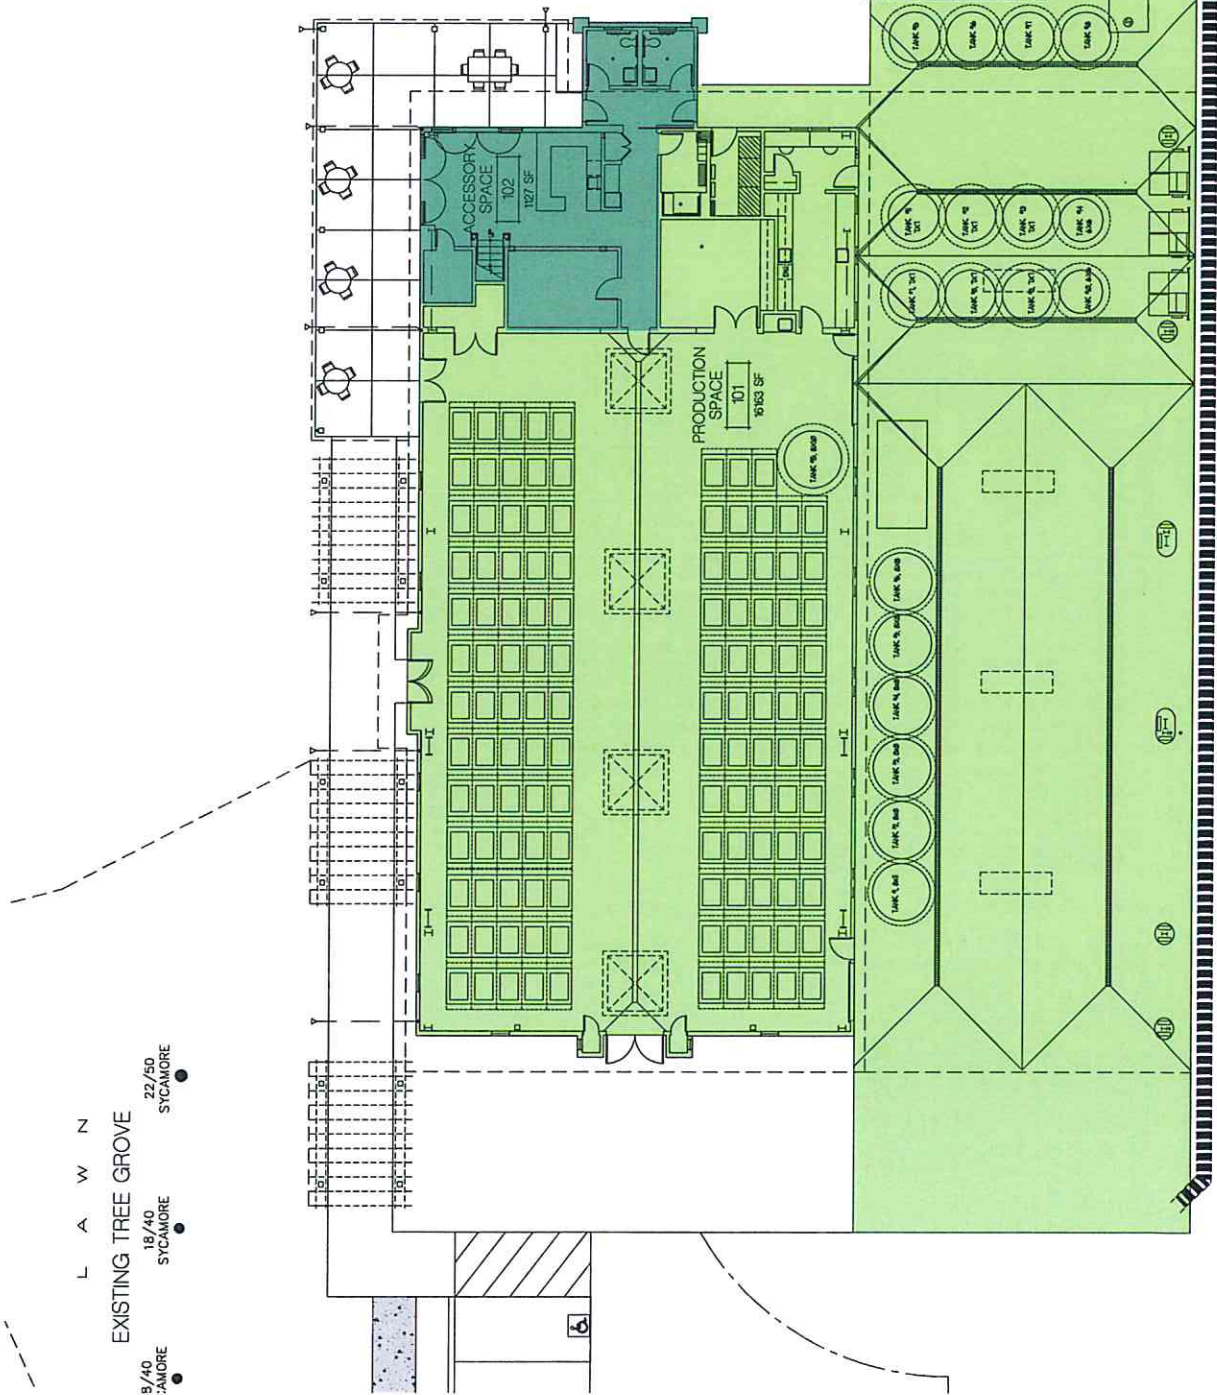

**EXISTING WINERY FIRST FLOOR PLAN - PRODUCTION AND ACCESSORY USE AREAS**

18/40


18/40  
 22/50  
 9/40  
 SYCAMORE  
 SYCAMORE  
 SYCAMORE



# LEGEND

- INDICATES EXISTING WINERY PRODUCTION FACILITIES
- INDICATES EXISTING WINERY ACCESSORY USE AREA
- INDICATES PROPOSED NEW WINERY PRODUCTION FACILITY
- INDICATES PROPOSED NEW WINERY ACCESSORY USE AREA

Copyright © 2016  
 ALL RIGHTS RESERVED. THIS DOCUMENT IS THE PROPERTY OF NICHOLS MELBERG ROSSETTO ARCHITECTS + ENGINEERS AND SHALL REMAIN THEIR PROPERTY. NO PART OF THIS DOCUMENT IS TO BE REPRODUCED OR TRANSMITTED IN ANY FORM OR BY ANY MEANS, ELECTRONIC OR MECHANICAL, WITHOUT THE WRITTEN PERMISSION OF NICHOLS MELBERG ROSSETTO ARCHITECTS + ENGINEERS.



**NICHOLS  
MELBERG  
ROSSETTO**  
 ARCHITECTS + ENGINEERS  
 550 WEST 10TH STREET, SUITE 300  
 LOS ANGELES, CA 90015  
 (310) 817-7700 (310) 691-0058 FAX  
 http://www.nmrdesign.com

CONSULTANTS

EXISTING AND PROPOSED WINERY BUILDING AREAS AND USES				
BUILDING	PRODUCT USE (SF)	ACCESS USE (SF)	TOTAL AREA (SF)	NOTES
WINERY	15163	127	15290	EXISTING USE - NO CHANGES
MECH. PLANT	460		460	
EXISTING RESIDENCE		2351	2351	2351 WHOLLY CONVERTED TO WINERY USE
EXIST. BARN	1424	473	1897	WHOLLY CONVERTED TO WAREHOUSE USE
EXIST. STORAGE BLDG.	529	599	1028	WHOLLY CONVERTED TO WAREHOUSE USE
TOTAL ALL BLDGS.	17586	2450	20036	
PROPOSED PERCENT ACCESSORY USE - 20.30%				

PROJECT NAME  
**WINERY EXPANSION FOR  
 ROBERT BIALE  
 VINEYARDS**  
 4028 BIG BANCH RD.  
 MAFPA, CA



SHEET TITLE  
**CONVERTED BUILDING FLOOR PLANS**

DRAWING STATUS  
**USE PERMIT  
 MODIFICATION**

REVISIONS  
 Sym. Description By Date  
 JELI PACCOMAGNISI 501.10.2015



Drawn By  
 SAG

Checked By  
 2015-10-01

Scale  
 AS NOTED

Job No.  
 16-491

SHEET No.  
**A102**

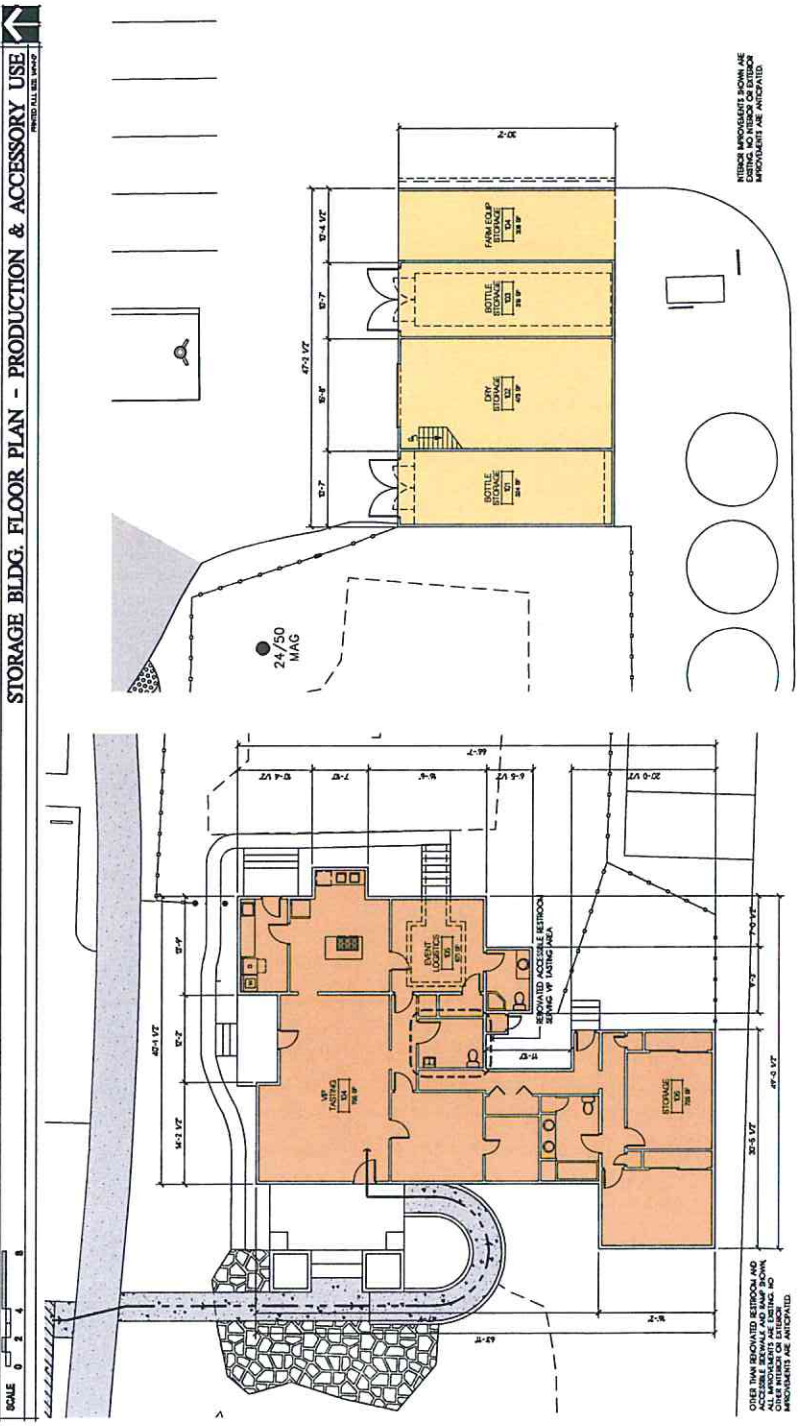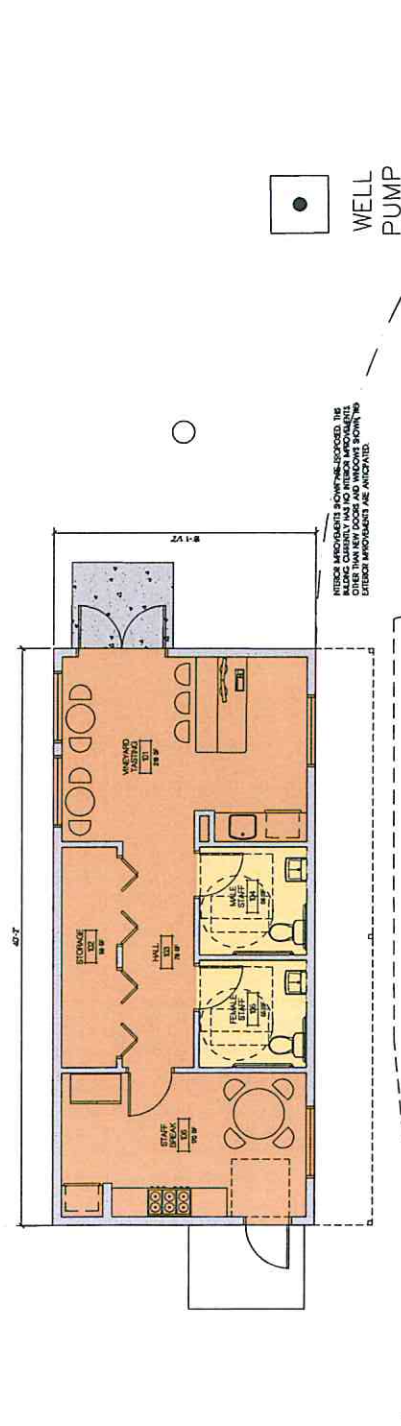

**VIP TASTING FLOOR PLAN - PRODUCTION & ACCESSORY USE**  
 PRELIMINARY PLAN


SCALE 0 1 2 3 4 5

OTHER THAN SHOWN, ALL ROOMS SHALL BE FINISHED TO MEET ALL APPLICABLE CODES AND ALL WORK SHALL BE PERFORMED IN ACCORDANCE WITH THE LATEST EDITIONS OF THE IBC AND ALL APPLICABLE LOCAL ORDINANCES.

# LEGEND



INDICATES EXISTING  
WINERY DEVELOPMENT  
AREA - 1,683 S.F.

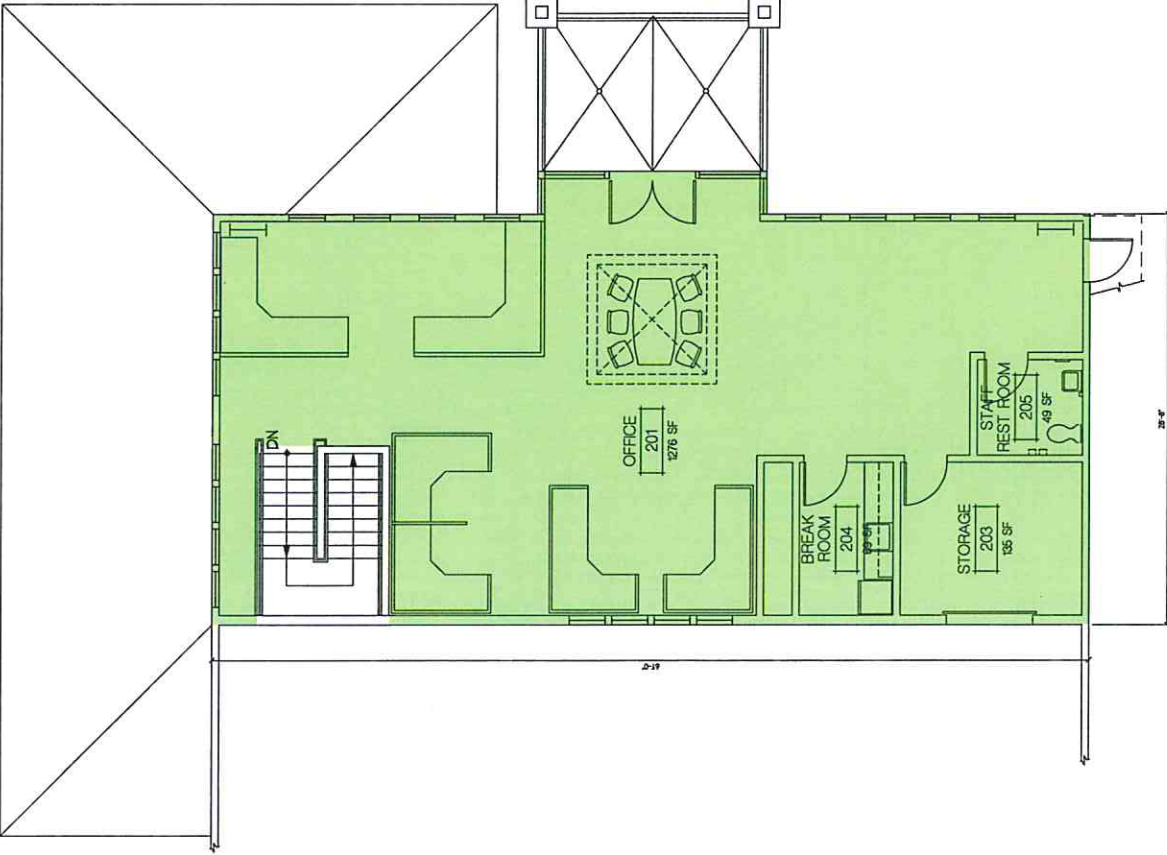

Copyright © 2016  
 In the State of California, the professional seal of the State Board of Professional Engineers, Architects, and Surveyors is hereby acknowledged.  
 NICHOLS  
 MEYERBERG  
 ROSSETTO  
 ARCHITECTS + ENGINEERS  
 556 MAIN STREET, SUITE 300  
 OAKLAND, CALIFORNIA 94612  
 (510) 861-1700 (510) 861-0338 FAX  
 http://www.nmrpa.com  
 CONSULTANTS

LICENSE STAMPS

PROJECT NAME  
**WINERY EXPANSION FOR**  
  
**ROBERT BIALE VINEYARDS**  
 4038 BIG BANCH RD.  
 NAPA, CA


SHEET TITLE  
**WINERY FIRST SECOND PLAN**

DRAWING STATUS  
**USE PERMIT MODIFICATION**

REVISIONS  
 Sym. Description By Date  
 REV. 1 RECOMMENDS SQ. FOOTAGE

Drawn By:	NMR
Checked By:	
Date Drawn:	2016-10-01
Scale:	AS
Job No.:	160491
SHEET No.:	A200

## EXISTING WINERY SECOND FLOOR PLAN

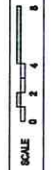


PRINTED FULL SIZE: 1/8"=1'-0"

10/17/16 10:42 AM  
 P:\04 - Client\04 - Biale Vineyards\04 - Winery\04 - Winery First Second Floor Plan - Existing.dwg  
 User: nmr\jmc  
 Plot Date: 10/17/16 10:42 AM  
 Plot Scale: 1/8"=1'-0"

# LEGEND

- INDICATES EXISTING WINERY PRODUCTION FACILITIES
- INDICATES EXISTING WINERY ACCESSORY USE AREA
- INDICATES PROPOSED NEW WINERY PRODUCTION FACILITY
- INDICATES PROPOSED NEW WINERY ACCESSORY USE AREA

**© 2016**  
 ALL RIGHTS RESERVED BY THE ARCHITECTS AND ENGINEERS.  
 NO PART OF THIS DOCUMENT IS TO BE REPRODUCED OR TRANSMITTED IN ANY FORM OR BY ANY MEANS, ELECTRONIC OR MECHANICAL, INCLUDING PHOTOCOPYING, RECORDING, OR BY ANY INFORMATION STORAGE AND RETRIEVAL SYSTEM, WITHOUT PERMISSION IN WRITING FROM THE ARCHITECTS AND ENGINEERS.  
 THE ARCHITECTS AND ENGINEERS ACCEPT NO LIABILITY FOR ANY DAMAGE, INCLUDING CONSEQUENTIAL DAMAGES, ARISING FROM THE USE OF THIS DOCUMENT.



**NICHOLS  
 MERMIG  
 ROSSETTO**  
 ARCHITECTS + ENGINEERS  
 555 MAIN STREET, SUITE 300  
 SAN FRANCISCO, CA 94102  
 (415) 774-1000 FAX (415) 774-1001  
<http://www.nmr.com>

CONSULTANTS

BUILDING	PRODUCT USE (S.F.)	ACCESS USE (S.F.)	TOTAL AREA (S.F.)	NOTES
WINERY	18,163	127	18,290	EXISTING USE - NO CHANGES
1st FLR	58			
2nd FLR		127		
TOTAL		18,290		
MECH. PLANT	480		480	
EXISTING RESIDENCE		2151	2151	WHOLLY CONVERTED TO WINERY USE
EXIST. BARN	1424		1424	WHOLLY CONVERTED TO WINERY USE
1st FLR	473			
LOFT				
TOTAL	129	599	728	WHOLLY CONVERTED TO WINERY USE
EXISTING STORAGE BLDG.	18177	532	18,709	WHOLLY CONVERTED TO WINERY USE
TOTAL BLDGS.			24,229	

PROPOSED PERCENT ACCESSORY USE - 26.08%

LICENSE STAMPS

PROJECT NAME  
**WINERY EXPANSION FOR**  
  
**ROBERT BIALE VINEYARDS**  
 4038 BIG BANCH RD.  
 MAPA, CA

SHEET TITLE  
**WINERY FIRST SECOND PLAN**


DRAWING STATUS  
**USE PERMIT MODIFICATION**

REVISIONS

Rev.	Description	Date
REV. 1	FOR COMMERCIAL USE PERMIT	05/12/16

Drawn By: NMR  
 Checked By: NMR  
 Date Drawn: 2016-12-01  
 Scale: AS  
 Job No.: 16-5491

SHEET No.  
**A201**

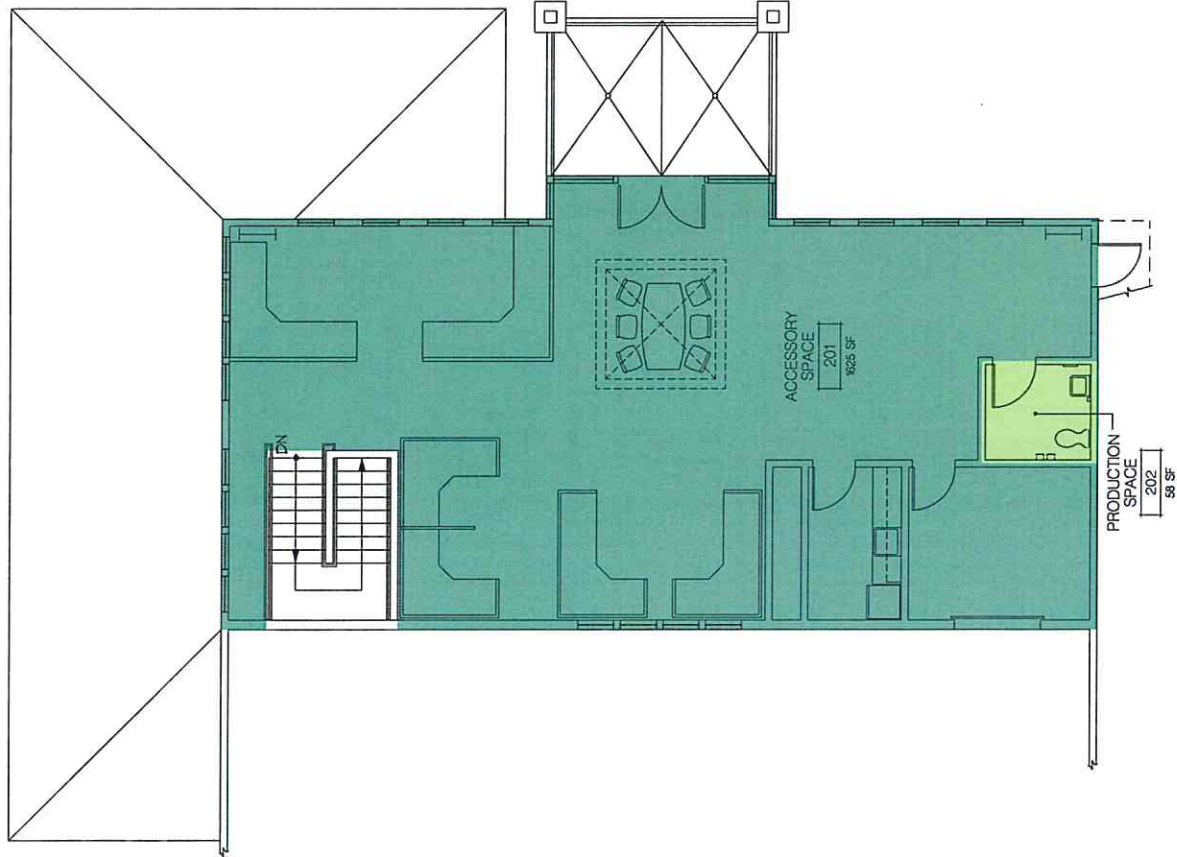

EXISTING WINERY SECOND FLOOR PLAN - PRODUCTION AND ACCESSORY USE AREAS

Copyright © 2018

10000 Wilshire Blvd, Suite 1000  
Beverly Hills, CA 90210  
Tel: 310.277.1100  
Fax: 310.277.1101  
www.nicholsmerg.com



**NICHOLS  
MERG  
ROSSETTO**  
ARCHITECTS + ENGINEERS  
555 MAIN STREET, SUITE 300  
CHICO, CA 95928  
(530) 893-1100 TEL FAX  
1827 www.nicholsmerg.com  
CONSULTANTS

LICENSING FRAMING

PROJECT NAME  
**WINERY  
EXPANSION  
FOR**



**ROBERT BIALE  
VINEYARDS  
4888 BAY AVENUE  
NAPA, CALIFORNIA**

SHEET TITLE  
**EXTERIOR  
ELEVATIONS**

DRAWING STATUS

**DD SET  
PRELIMINARY  
NOT FOR CONSTRUCTION**

REVISIONS

Rev.	Description	Date


Drawn By	NMR
Checked By	SAG
Date Drawn	2016-08-25
Scale	AS NOTED
Job No.	16-5491

SHEET No.

**A301**



**EAST ELEVATION**  
SCALE: 1/8"=1'-0"

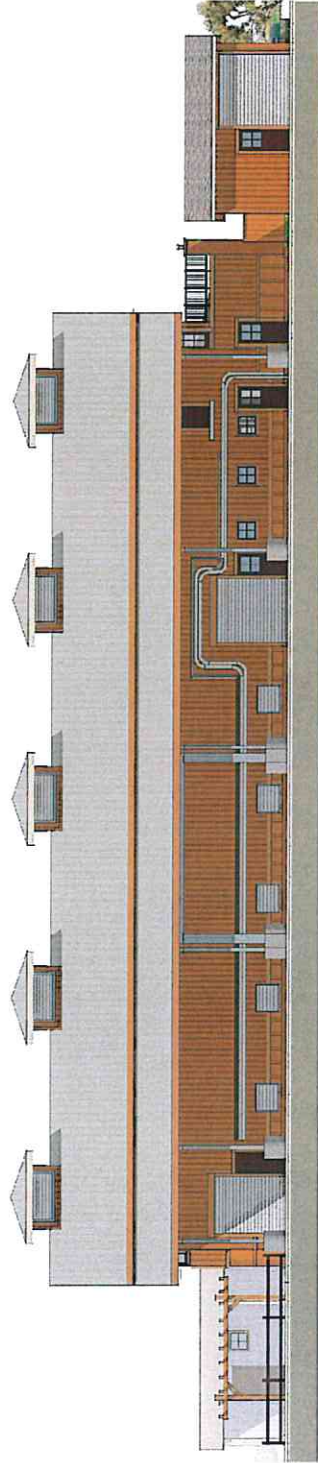

**SOUTH ELEVATION**  
SCALE: 1/8"=1'-0"

Copyright © 2016

2242003 03 16  
1/2  
1/4  
1/8  
1/16  
1/32  
1/64  
1/128  
1/256  
1/512  
1/1024  
1/2048  
1/4096



**NICHOLS  
MERG  
ROSSETTO**

**ARCHITECTS + ENGINEERS**  
255 MAIN STREET, SUITE 300  
LOS ANGELES, CALIFORNIA 90012  
(310) 811-7170 (310) 811-0134 FAX  
<http://www.nmrdesign.com>

CONSULTANTS

LICENSE STAMPS

PROJECT NAME  
**WINERY  
EXPANSION  
FOR**



**ROBERT BIALE  
VINEVA BROS  
4036 BIG RANCH RD.  
NAPA, CALIFORNIA**

SHEET TITLE  
**EXTERIOR  
ELEVATIONS**

DRAWING STATUS

**DD SET  
PRELIMINARY  
NOT FOR CONSTRUCTION**


REVISIONS

Rev. Description	Date


Drawn By	NMR
Checked By	SAG
Date Drawn	2/16/2016
Scale	AS NOTED
Job No.	16-5491

SHEET No.

**A302**

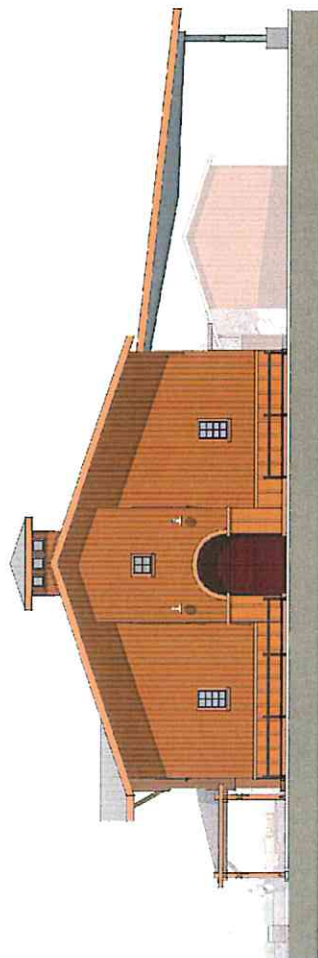

**WEST ELEVATION**  
SCALE: 1/8"=1'-0"

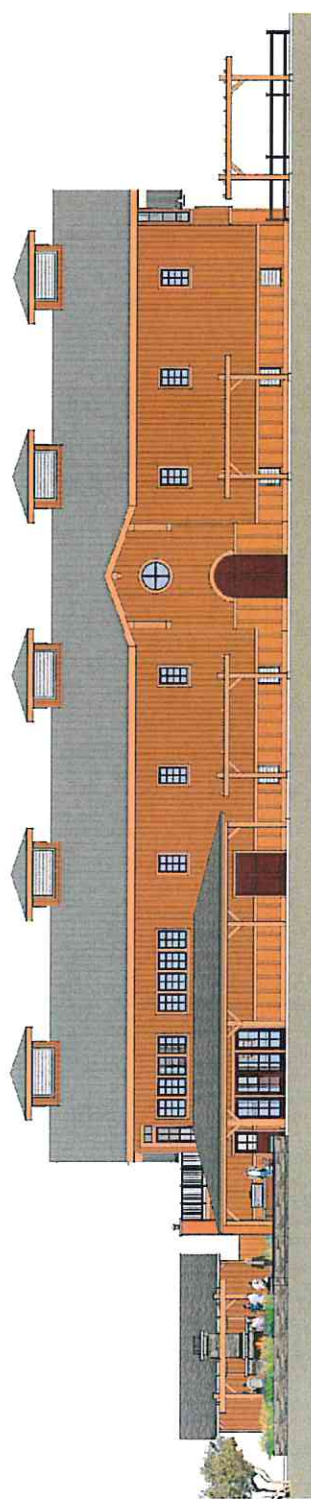



**NORTH ELEVATION**  
SCALE: 1/8"=1'-0"



**NICHOLS  
MEYER  
ROSSETTO**  
ARCHITECTS + ENGINEERS  
555 MAIN STREET, SUITE 300  
DUBLIN, CA 94568  
(925) 835-1100 FAX  
www.nicholsmeyer.com

CONSULTANTS

LICENSING STAMPS

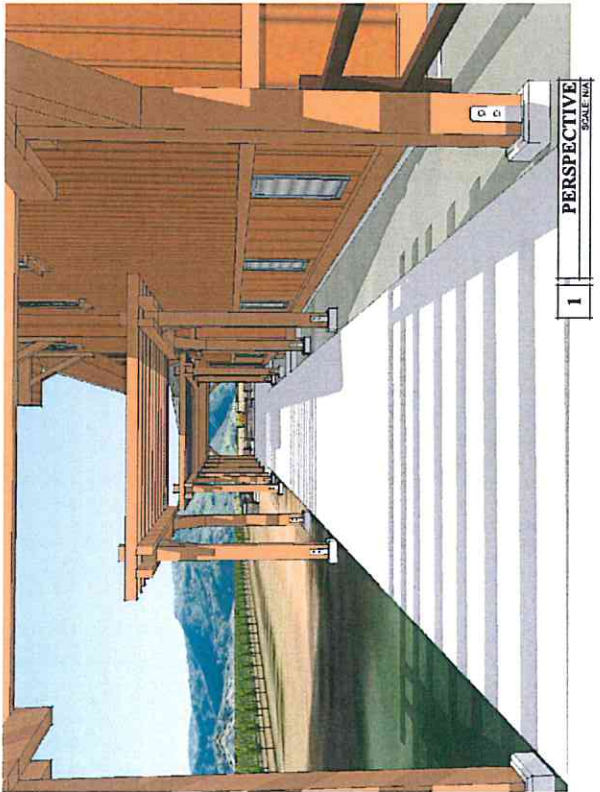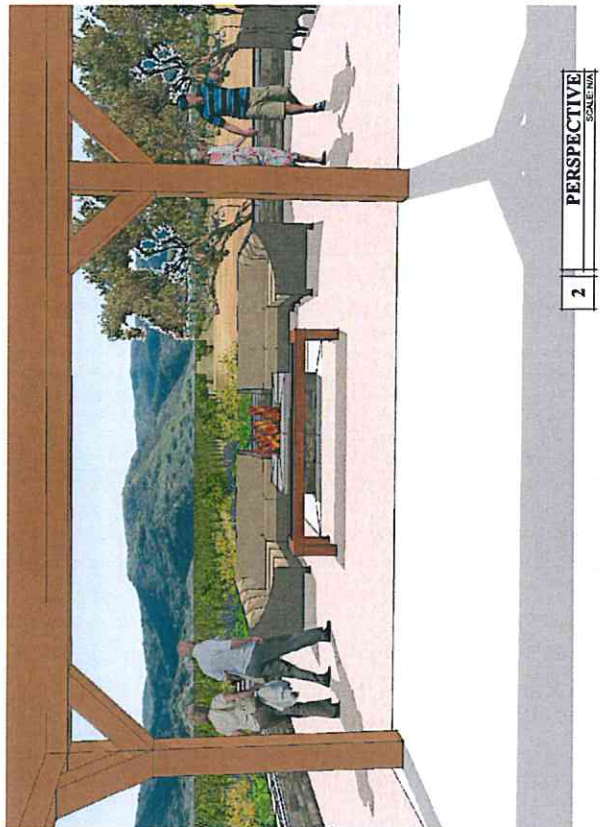

PROJECT NAME  
**WINERY  
EXPANSION  
FOR**



**ROBERT BIALE  
VINEYARDS**  
4838 BUCKLEBUSH RD.  
NAPA, CALIFORNIA

SHEET TITLE  
**BACK PORCH  
EXPANSION  
PERSPECTIVES**

DRAWING STATUS

**DD SET  
PRELIMINARY  
NOT FOR CONSTRUCTION**

REVISIONS	Date

Drawn By	NMR
Checked By	SAG
Date Drawn	2016-09-25
Scale	AS NOTED
Job No.	16-5491

SHEET No.  
**A303**

Copyright © 2018

555 MAIN STREET, SUITE 300  
SANTA ANA, CALIFORNIA 92701  
(949) 440-1111 (949) 440-1114 FAX  
http://www.nmrdesign.com




**NICHOLS  
MERG  
ROSSETTO**  
ARCHITECTS + ENGINEERS  
555 MAIN STREET, SUITE 300  
(949) 440-1111 (949) 440-1114 FAX  
http://www.nmrdesign.com

CONSULTANTS

LICENSE STAMPS



**1** STORAGE SHED - SOUTH & WEST SIDES  
SCALE: N/A

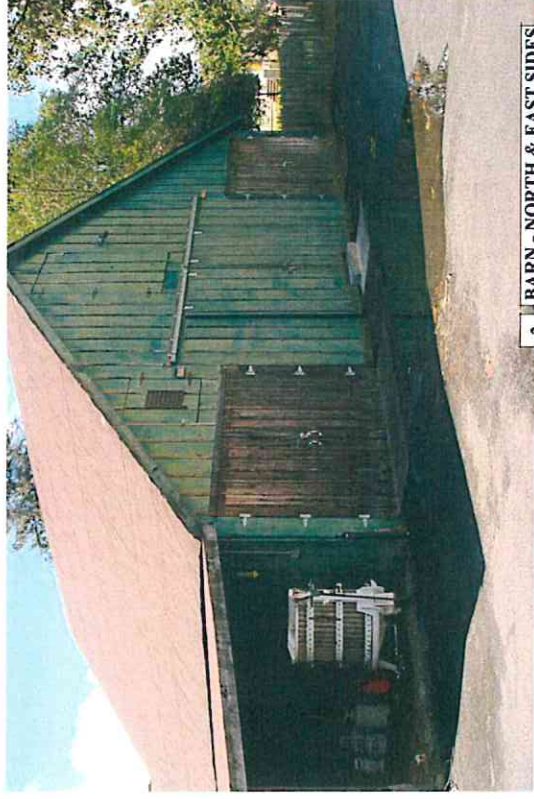

**2** BARN - NORTH & EAST SIDES  
SCALE: N/A



**3** STORAGE SHED - SOUTH & EAST SIDES  
SCALE: N/A



**4** BARN - SOUTH & EAST SIDES  
SCALE: N/A

PROJECT NAME:  
**WINERY  
EXPANSION  
FOR**




SHIBET TITLE:  
**EXISTING  
BUILDING PHOTOS**

DRAWING STATUS:  
**DD SET  
PRELIMINARY  
NOT FOR CONSTRUCTION**

REVISIONS:  
Sym. Description Date

Drawn By: NMR  
Checked By: SAG  
Date Drawn: 2016-05-25  
Scale: AS NOTED  
Job No.: 16-5481

SHIBET No.:  
**A304**

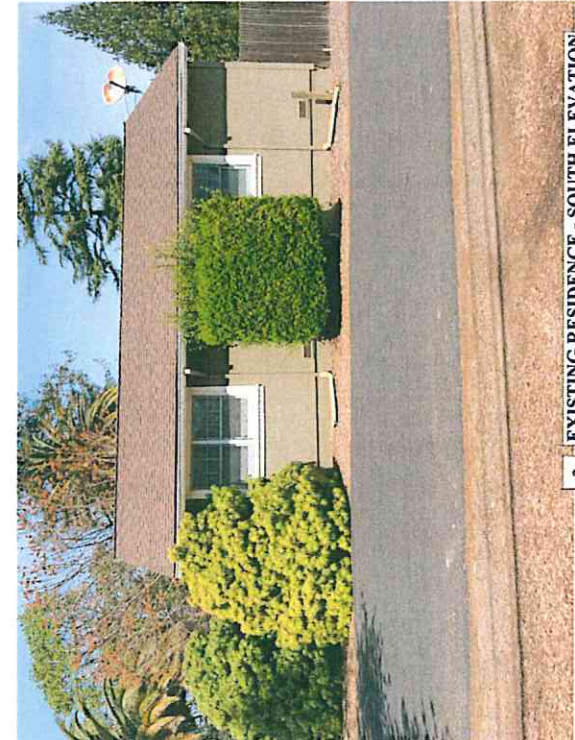


3 EXISTING RESIDENCE - SOUTH ELEVATION  
SCALE: N/A



1 EXISTING RESIDENCE - NORTH ELEVATION  
SCALE: N/A



4 EXISTING RESIDENCE - WEST ELEVATION  
SCALE: N/A

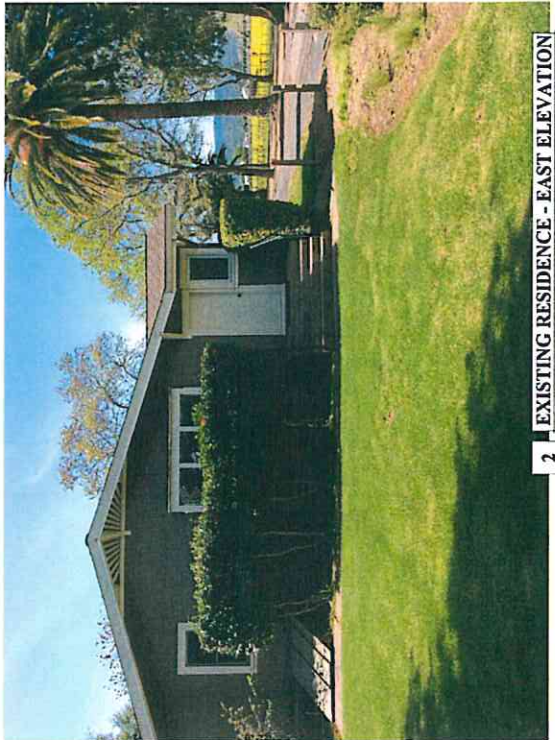

2 EXISTING RESIDENCE - EAST ELEVATION  
SCALE: N/A

Copyright © 2016  
 NICHOLS MEYERBERG ROSSETTO  
 ARCHITECTS + ENGINEERS  
 556 MAIN STREET, SUITE 300  
 NAPA, CALIFORNIA 94559  
 (707) 811-1110 (707) 811-2128 FAX  
<http://www.nmrdesign.com>  
 CONSULTANTS

LICENSE STAMPS

PROJECT NAME  
 WINERY  
 EXPANSION  
 FOR



ROBERT BIALE  
 VINEYARDS  
 4034 BIG RANCH RD.  
 NAPA, CALIFORNIA

SHEET TITLE  
 EXISTING  
 RESIDENCE  
 PHOTOS

DRAWING STATUS  
 DD SET  
 PRELIMINARY  
 NOT FOR CONSTRUCTION

REVISIONS

Sym.	Description	Date

Drawn By	NMR
Checked By	SAG
Date Drawn	2016-08-25
Scale	AS NOTED
Job No.	16-5491
SHEET No.	

A305







CONTRACT # 2015  
 THE CITY OF NICHOLS MEMPHIS  
 1500 MARKET STREET, SUITE 100  
 NICHOLS MEMPHIS, TN 38103  
 TEL: 901.527.1100 FAX: 901.527.1101  
 WWW.NICHOLSMEMPHIS.COM



**NICHOLS  
MEMPHIS  
ROSSETTO**  
 ARCHITECTS - ENGINEERS  
 555 MAIN STREET, SUITE 300  
 CHOO, CA 95003  
 925.838.8383 FAX  
 925.838.8383  
 NEW@NICHOLSMEMPHIS.COM  
 CONSULTANTS

LICENSE NUMBER

PROJECT NAME  
**WINERY  
EXPANSION  
FOR**



ROBERT BIALE  
**VINEYARDS**  
 4058 BIG BRANCH RD.  
 HUNTSVILLE, TN

SHEET TITLE  
**PARTIAL STORMWATER  
CONTROL PLAN**

ISSUING STATUS  
**USE PERMIT  
MODIFICATION**


REVISIONS  
 Description By Date  
 REV. 10 COMMENTS BJA, 10/20/15

Drawn By	SAO
Checked By	
Date Drawn	2015-10-01
Scale	AS NOTED
Job No.	15-049
SHEET No.	

**C220**

- LEGEND**
- INDICATES PROPOSED NEW ASPHALT CONCRETE DRIVEWAY
  - CONCRETE CURB
  - INDICATES PROPOSED NEW SIDEWALK
  - INDICATES EXISTING SIDEWALK
  - INDICATES EXISTING DRIVEWAY
  - INDICATES EXISTING STREET
  - INDICATES EXISTING UTILITY LINE OR PROPERTY LINE
  - DISTANCE BETWEEN PROPERTY LINES
  - INDICATES STORM DRAIN PIPE, ALL INFORMATION FOR CONTROL PLAN FOR SIZE AND SLOPE
  - INDICATES EXISTING FIRE HYDRANT

- SHEET NOTES**
- 1 NEW ASPHALT CONCRETE DRIVEWAY TO BE DEMOLISHED
  - 2 NEW NAPA COUNTY G-11 DRIVEWAY TURBOKIT
  - 3 NAPA COUNTY G-13 HAMMER-HEAD FIVE APPROXIMATE TURNING ZONE
  - 4 UNPAVED PARKING SPACES AND LOADING ZONE
  - 5 EXISTING CONCRETE CURB, STALLS, PERIMETER CONCRETE CURB, STALLS AND STREETS TO BE DEMOLISHED AND RECONSTRUCTED TO MEET STREET STANDARD DETAIL P-1
  - 6 NEW ACCESSIBLE WALKWAY AND HAMP TO MEET ADA REQUIREMENTS
  - 7 LOTS OF 100-34-14-1-1 FLOOD PLAN
  - 8 CLASS B CONCRETE WALK EMPLOYEE PARKING AREA
  - 9 STORM DRAIN PIPES APPROVED UNDER NAPA COUNTY PERMITTING DEPARTMENT FOR C20 STORMWATER CONTROL PLAN
  - 10 SEE SHEET C20 STORMWATER CONTROL PLAN FOR STORMWATER CONTROL PLAN
  - 11 SOLID WASTE COLLECTION, GARBAGE, RECYCLABLES AND GREEN WASTE
  - 12 EXISTING VET FARM WATERMAIN
  - 13 EXISTING WINEERY HIGH AND LOW ROOF PLAN
  - 14 EXISTING 80' PARKING ROAD STORM WATER OVERFLOW PARKING AREA WITH 10" WASH PROPOSED BOTTOM OF DRAIN 4'
  - 15 PROPOSED DRAIN 9' LANDSCAPED PLANTER RETENTION AREA
  - 16 EXISTING STORMWATER POLLUTANT SOURCE

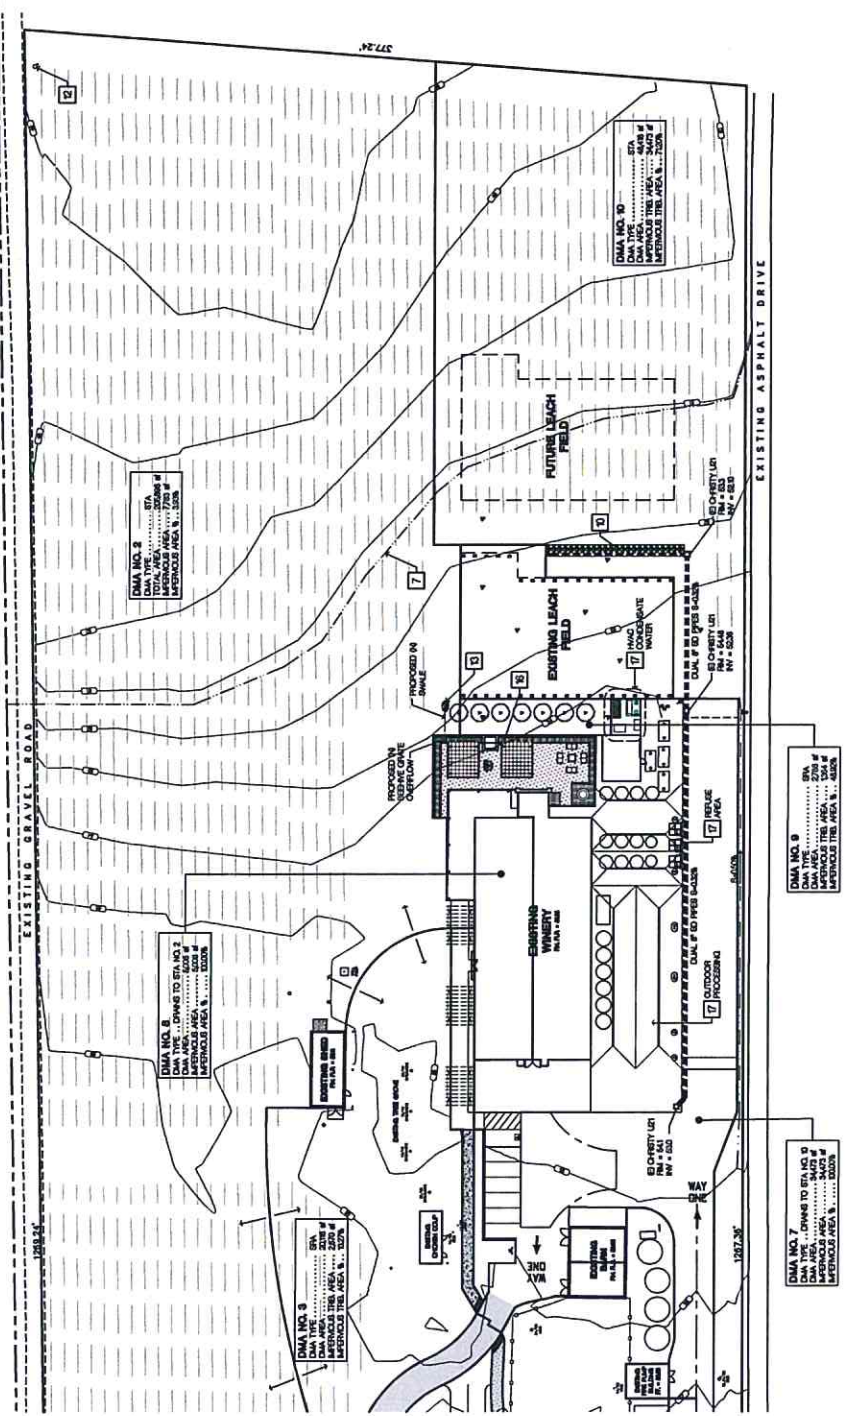

**PARTIAL STORMWATER CONTROL PLAN - EAST**

PRINTED FULL SIZE 11x17"  
 SCALE 0' 10' 20' 30' 40' 50' 60'

10/20/15  
 THE CITY OF NICHOLS MEMPHIS  
 1500 MARKET STREET, SUITE 100  
 NICHOLS MEMPHIS, TN 38103  
 TEL: 901.527.1100 FAX: 901.527.1101  
 WWW.NICHOLSMEMPHIS.COM