

"J"

Graphics


NAPA COUNTY LAND USE PLAN 2008 - 2030

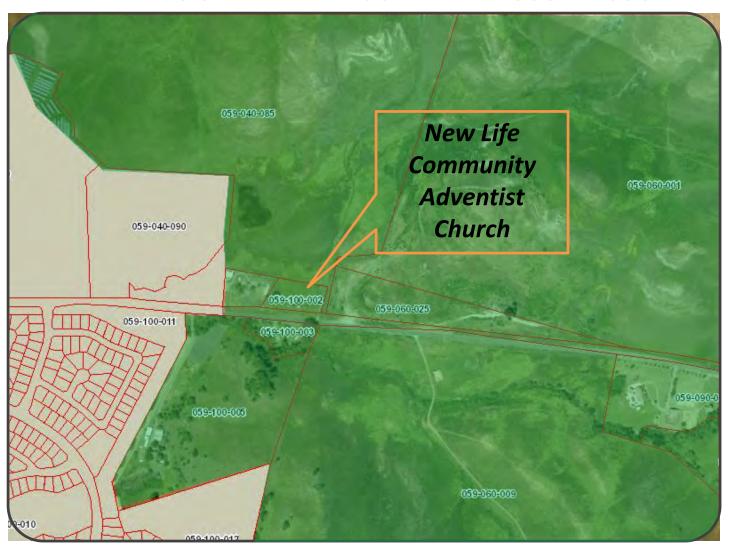

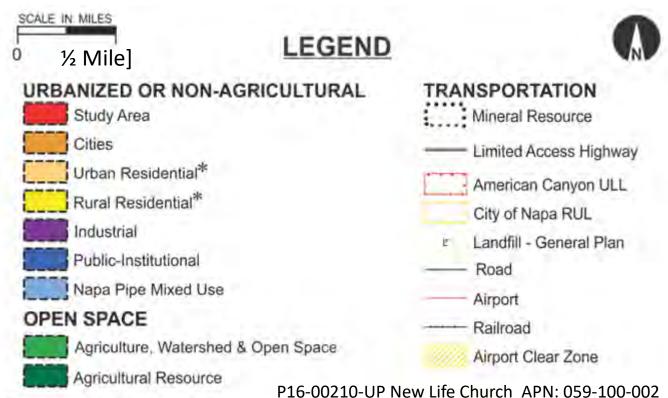

Map Date: 08-21-2019

* See Action sem AGUU-114.1 regarding agriculturally coned areas within these land use designations

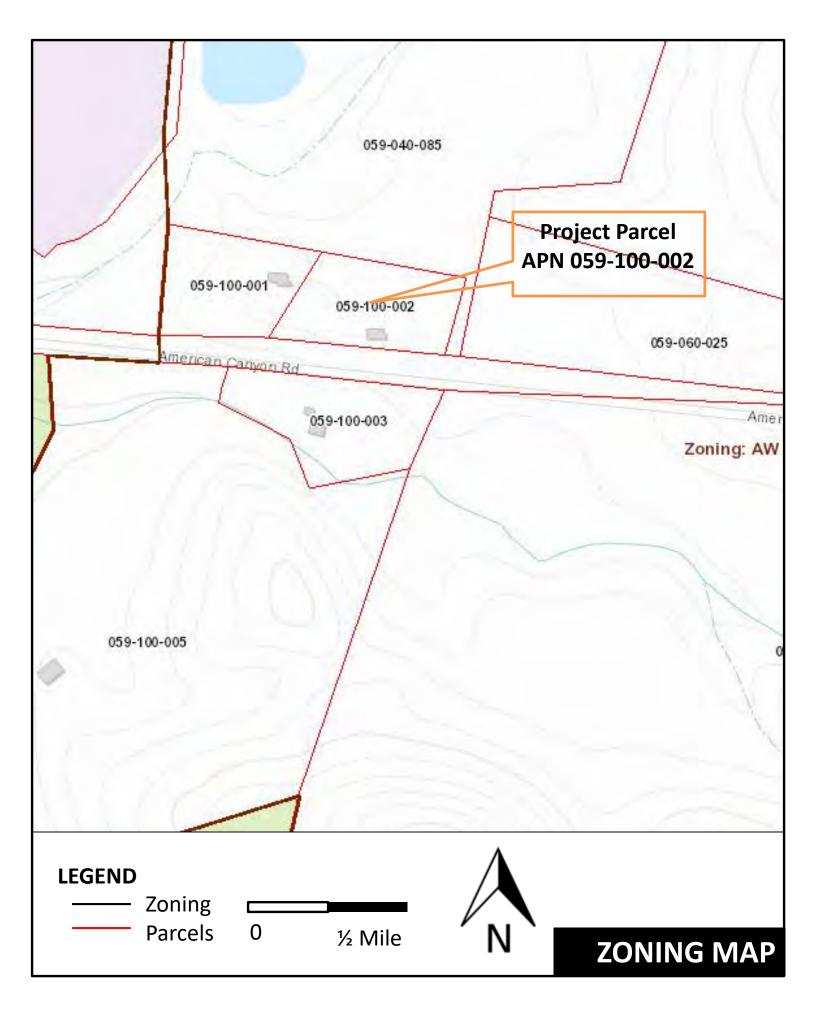





H. Adams LEED AP BD + C Credential hadam/arch@hotmail.com 6281 Butterfield Way Placerville, CA 95667 (916) 217-5879

> MECHANICAL ENGINEER DOUGLAS LOVELL, PE 4833 GRADUATES LANE SACRAMENTO, CA 95841 Phone: (916) 484-7779
> e-mail: dlovell49@hotmail.com
> Registered Mechanical Engineer M25745 Expiration date 3/31/2017

ELECTRICAL DESIGNER ALI KAZEMI 11745 NEW MELONES CIRCLE GOLD RIVER, CA 95670 Phone: (916) 397-2579 e-mail: alikazemi@sbcglobal.net

Electrical Consultant

Description Date

NEW CHURCH for NEW LIFE COMMUNITY SEVENTH-DAY ADVENTIST CHURCH NAPA COUNTY, CALIFORNIA

SITE PLAN

Project Number Project number Issue Date Drawn by Author Checker Checked by

A-1Scale

1" = 20'-0"


1 Site 1" = 20'-0"


NORTH


SECURITY CAMERAS REQUIRED MINIMUM LEVELS. LIGHTING SHALL MEET LIGHT POLLUTION REDUCTION STANDARDS REQUIRED BY THE

CALIFORNIA GREEN BUILDING CODE 5.106.8. FOR THE FEW EVENTS DURING THE YEAR WHERE ADDITIONAL PARKING IS NEEDED; OFF SITE PARKING WITH A SHUTTLE SERVICE; OR PARKING ON THE PROPERTY TO THE NORTH WILL BE PROVIDED BY THE CHURCH.

USE PERMIT #P16-00210-UP; 1451 AMERICAN CANYON ROAD; APN: 059-100-020. 7. ALL SURROUNDING PROPERTIES ARE ZONED AW.

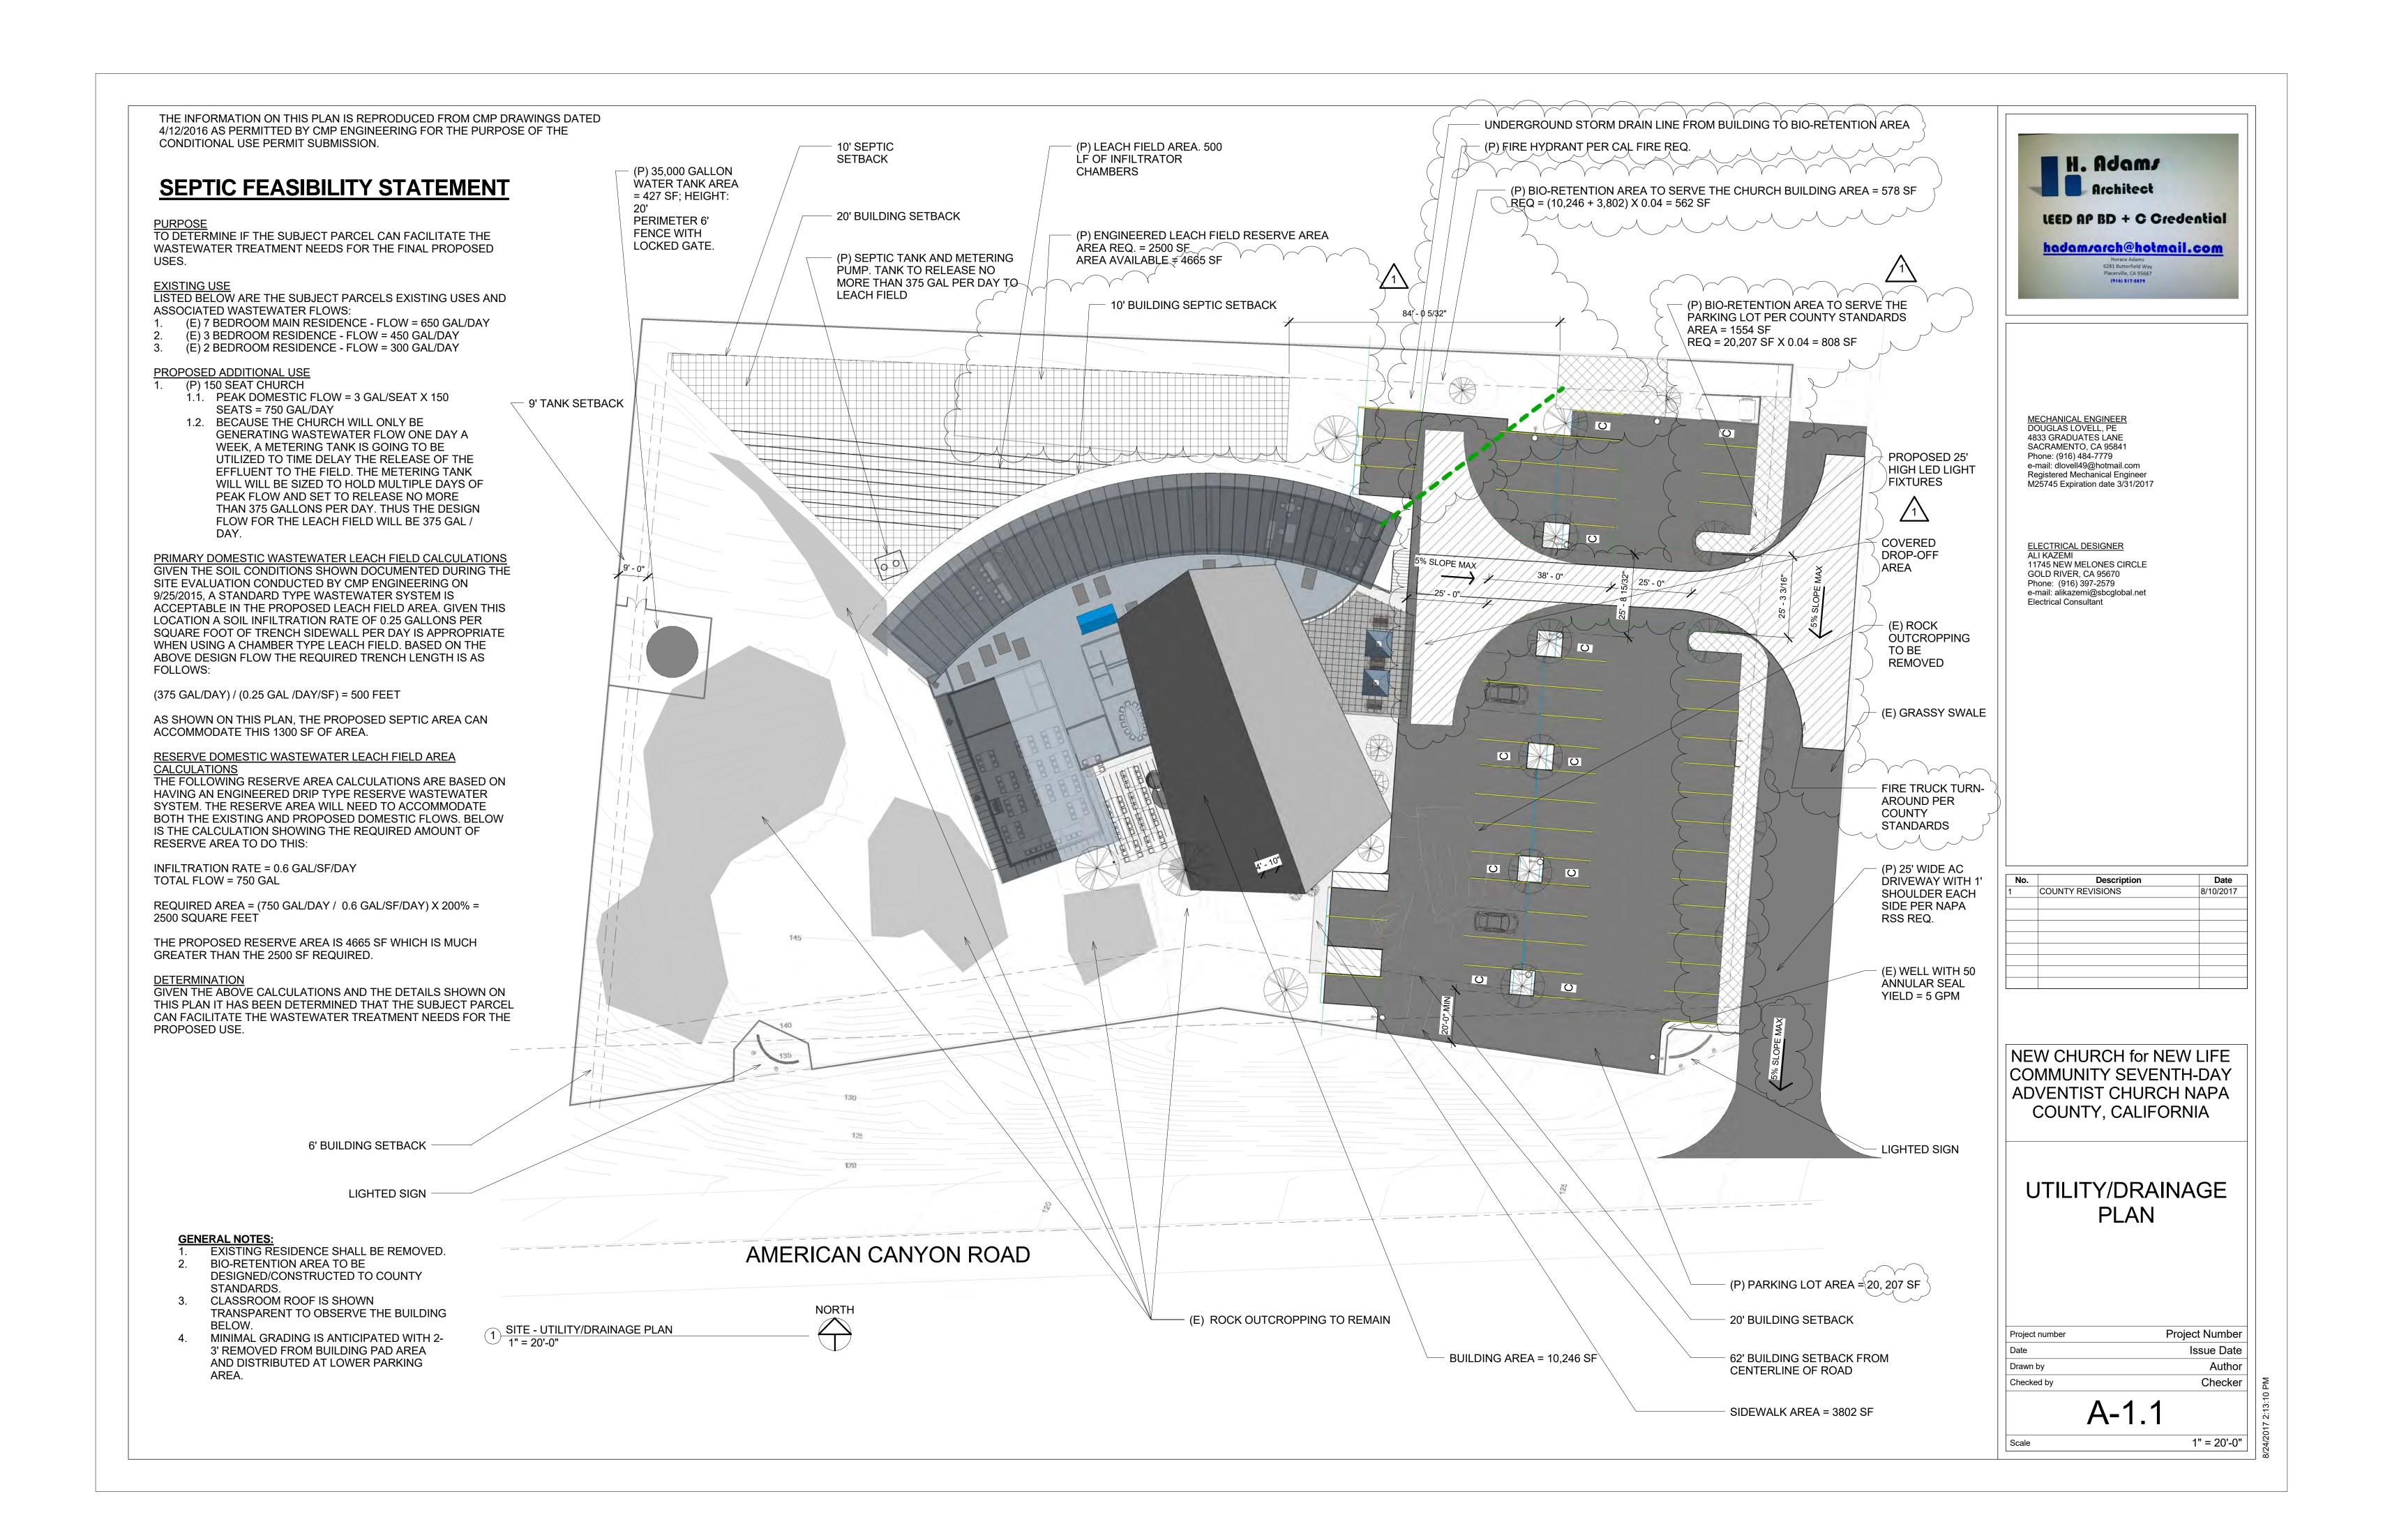

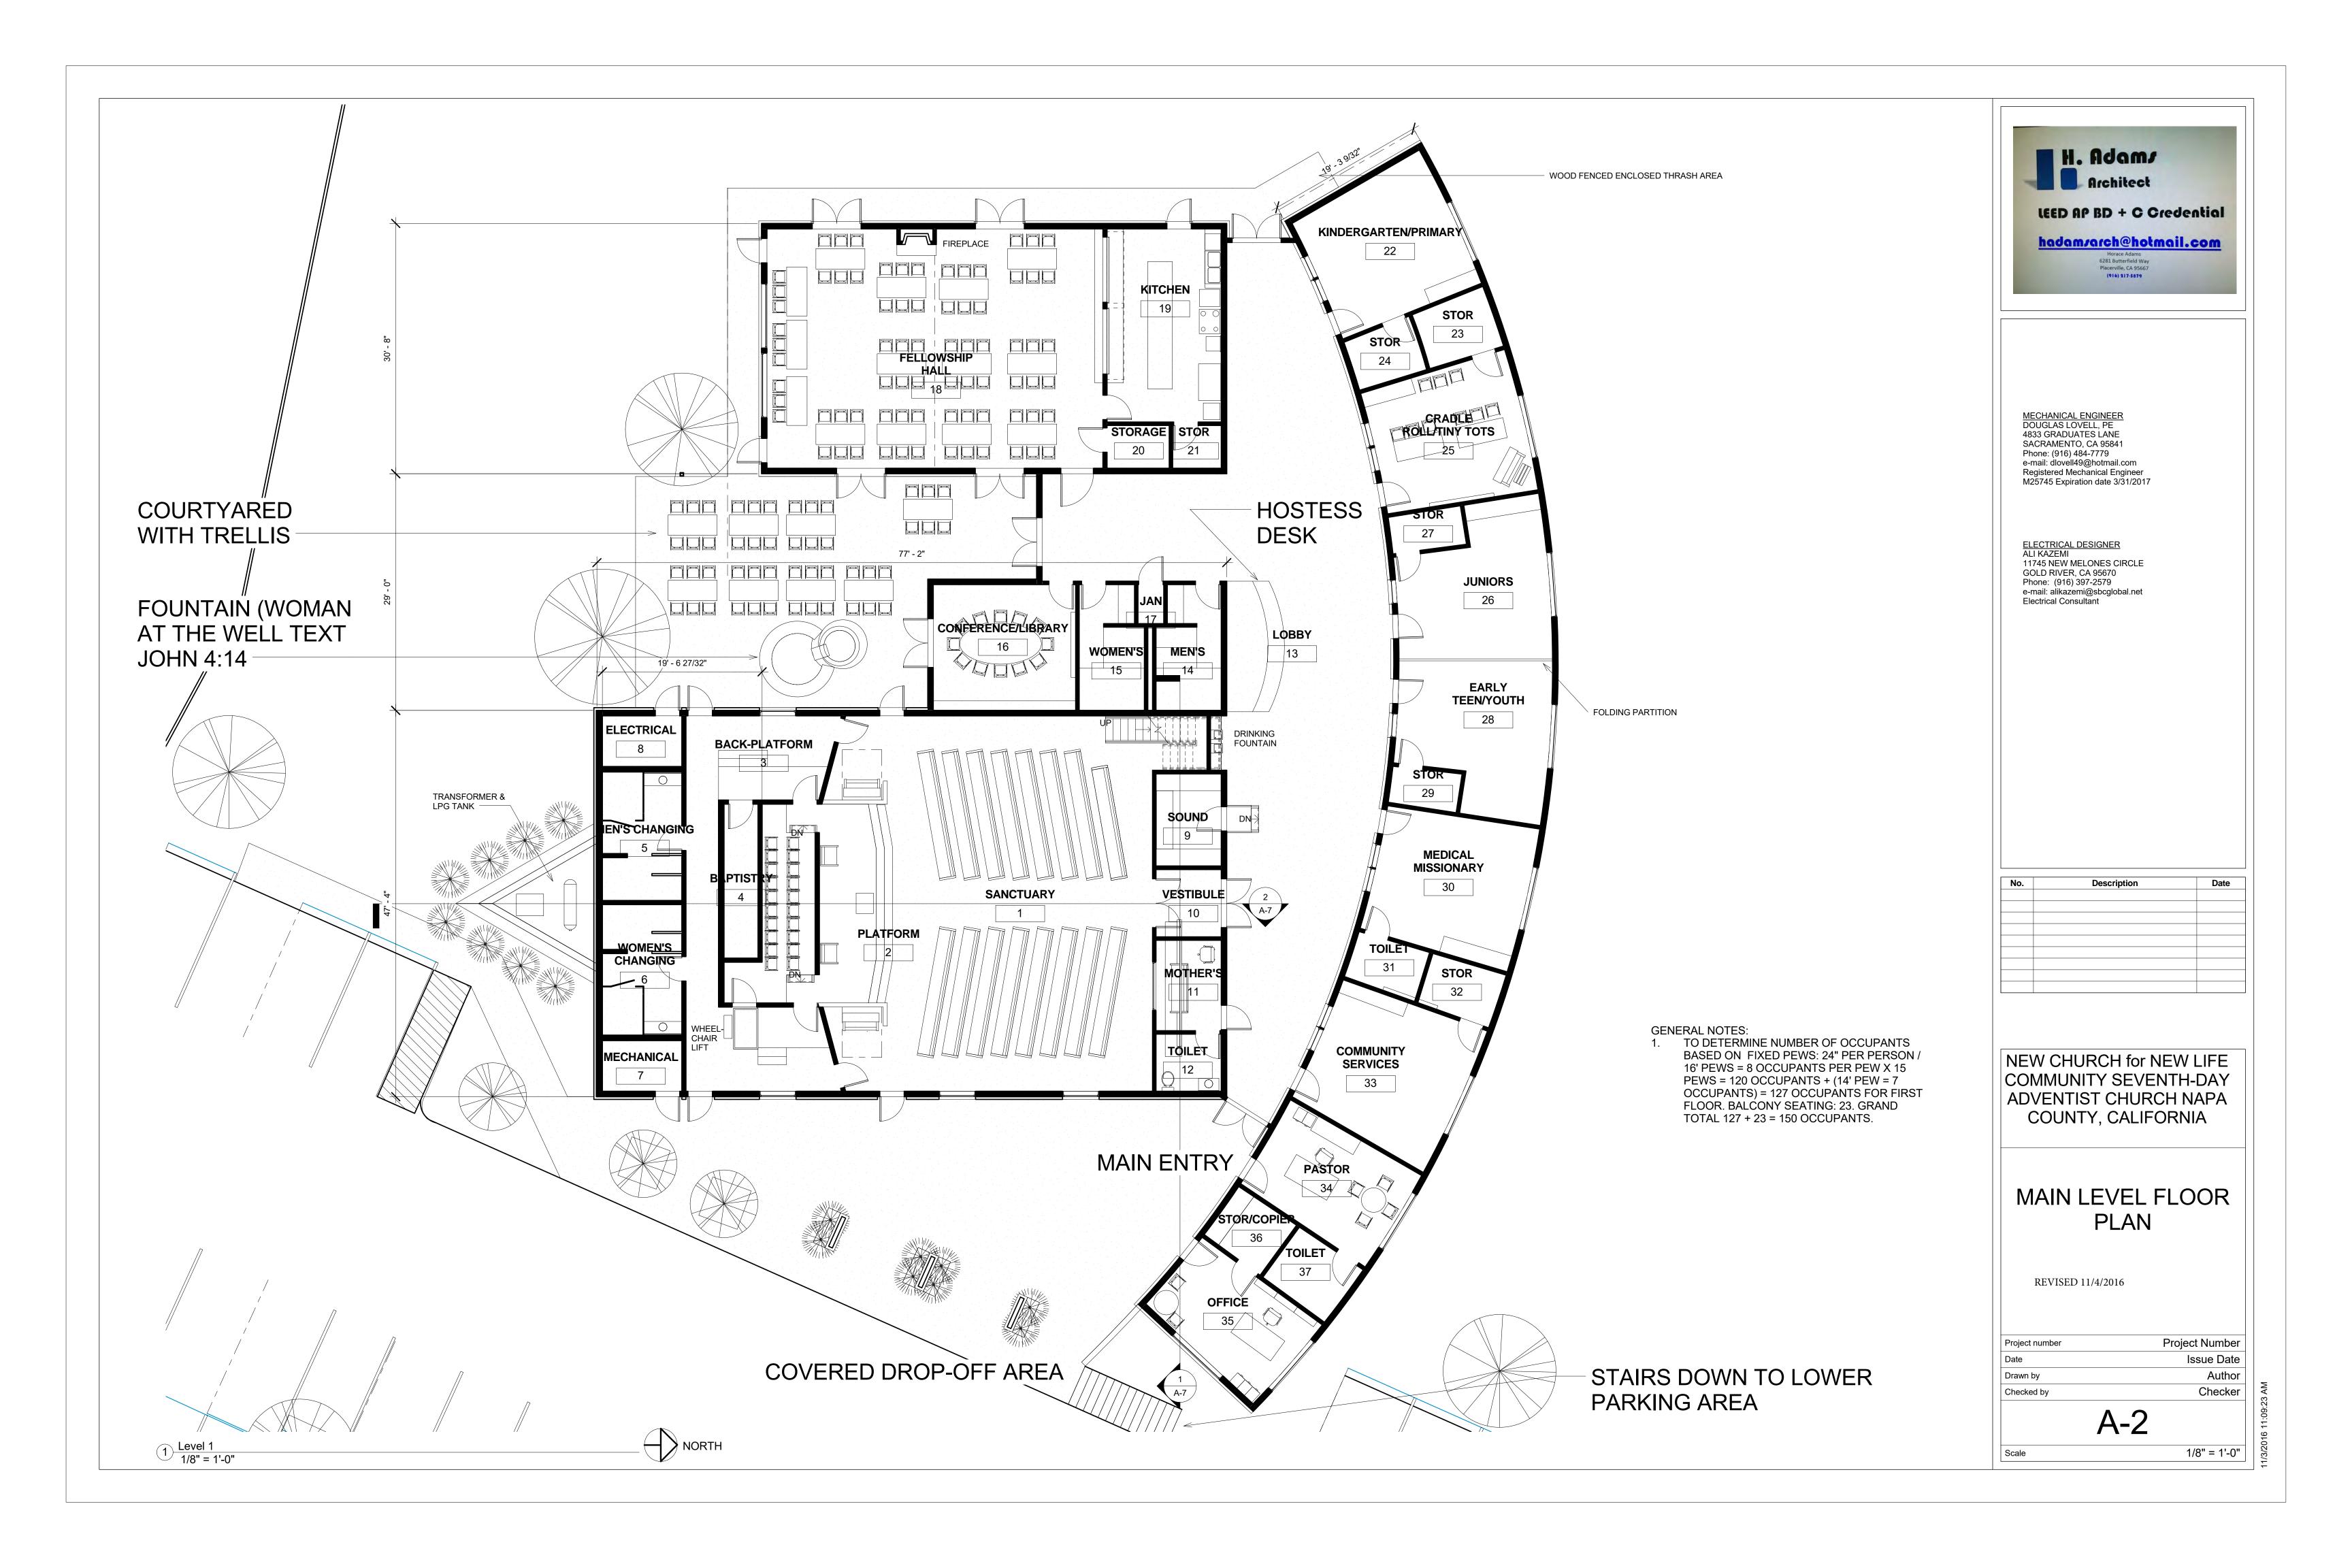

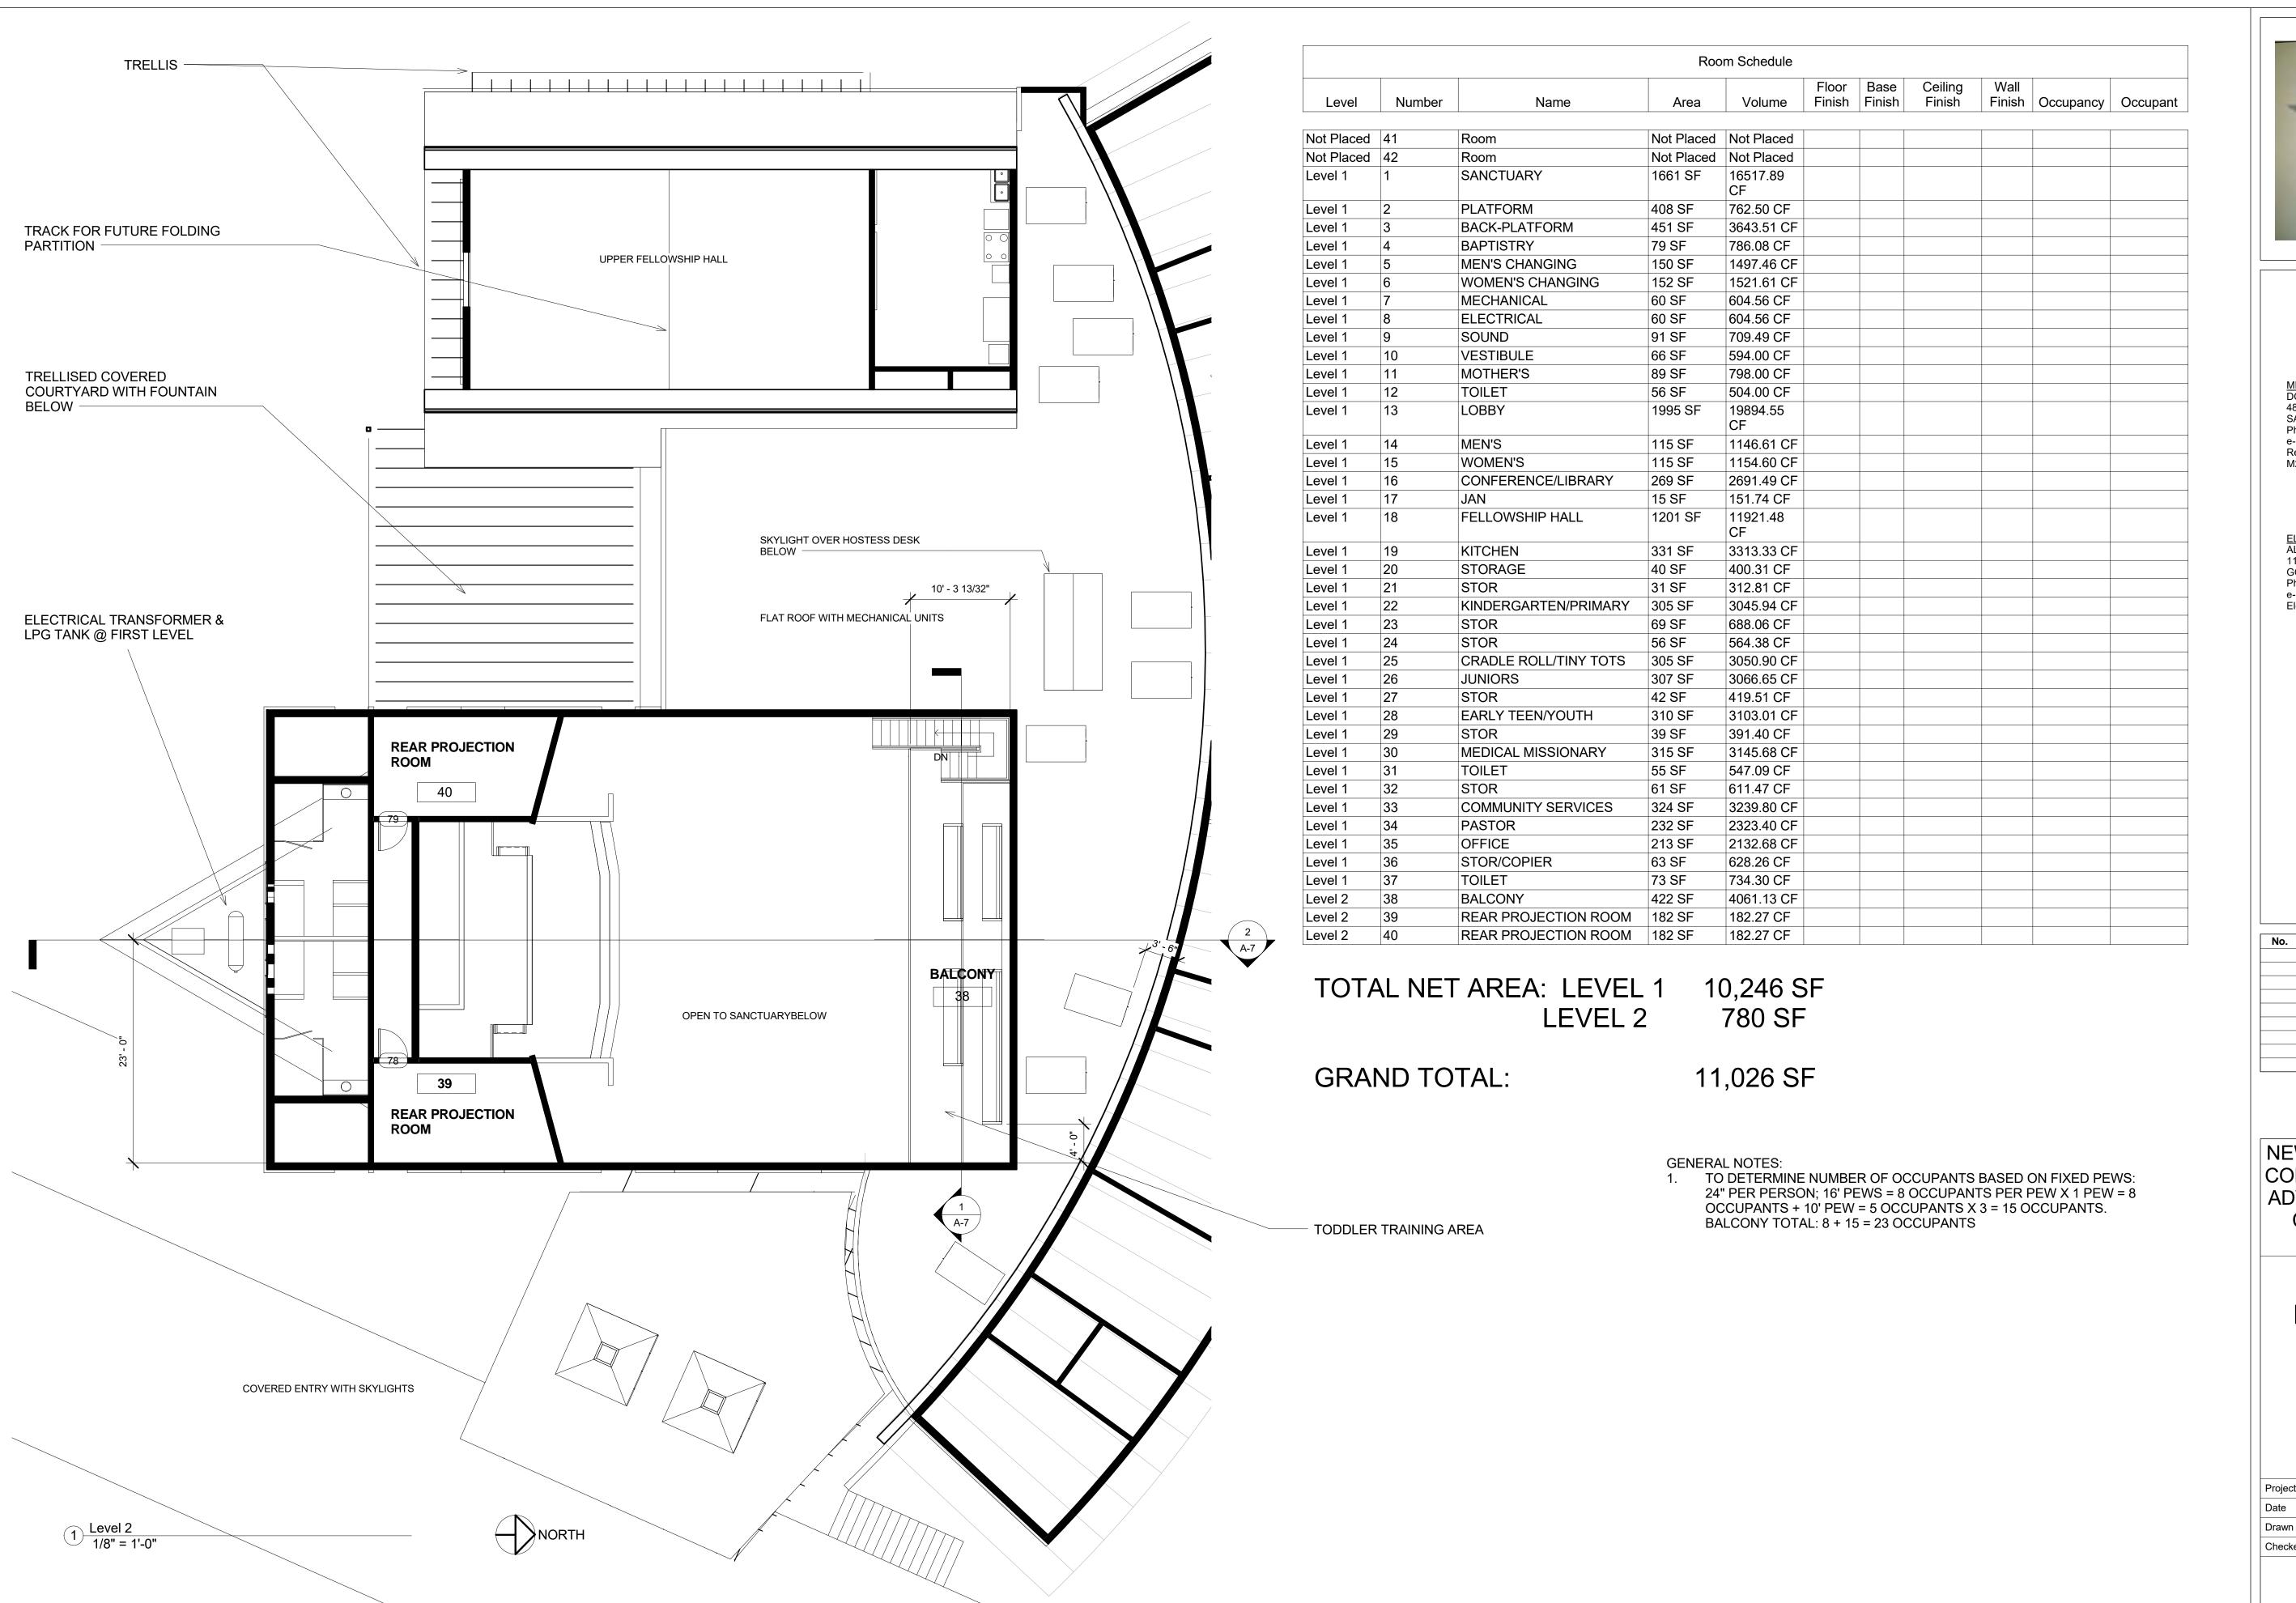



ELECTRICAL DESIGNER
ALI KAZEMI

11745 NEW MELONES CIRCLE GOLD RIVER, CA 95670 Phone: (916) 397-2579 e-mail: alikazemi@sbcglobal.net Electrical Consultant

0.	Description	Date

NEW CHURCH for NEW LIFE COMMUNITY SEVENTH-DAY ADVENTIST CHURCH NAPA COUNTY, CALIFORNIA

BALCONY FLOOR PLAN

REVISED 11/4/2016

Project number	Project Number
Date	Issue Date
Drawn by	Author
Checked by	Checker

A-3

Scale

1/8" = 1'-0"



1 RENDERING FROM SOUTHEAST 12" = 1'-0"

STAINED GLASS WINDOWS AT SANCTUARY

PAINTED STUCCO FINISH

STONE VENEER

STANDING SEAM METAL ROOF

STAINED WOOD TRELLIS





MECHANICAL ENGINEER
DOUGLAS LOVELL, PE
4833 GRADUATES LANE
SACRAMENTO, CA 95841
Phone: (916) 484-7779
e-mail: dlovell49@hotmail.com
Registered Mechanical Engineer
M25745 Expiration date 3/31/2017

ELECTRICAL DESIGNER
ALI KAZEMI
11745 NEW MELONES CIRCLE
GOLD RIVER, CA 95670
Phone: (916) 397-2579
e-mail: alikazemi@sbcglobal.net
Electrical Consultant

No.	Description	Date

NEW CHURCH for NEW LIFE COMMUNITY SEVENTH-DAY ADVENTIST CHURCH NAPA COUNTY, CALIFORNIA

PERSPECTIVE LOOKING FROM THE SOUTHEAST & SOUTHWEST

REVISED 11/4/2016

Project number Proj Date Drawn by Checked by	A-4	
Date	Checke	r
	Autho	r
Project number Proj	Issue Date)
Ducit of words on Ducit	oject Numbe	r

12" = 1'-0"

2 RENDERING FROM SOUTHWEST 12" = 1'-0"







ELECTRICAL DESIGNER
ALI KAZEMI
11745 NEW MELONES CIRCLE
GOLD RIVER, CA 95670
Phone: (916) 397-2579
e-mail: alikazemi@sbcglobal.net
Electrical Consultant

No.	Description	Date


NEW CHURCH for NEW LIFE COMMUNITY SEVENTH-DAY ADVENTIST CHURCH NAPA COUNTY, CALIFORNIA

PERSPECTIVE LOOKING FROM THE NORTHWEST

REVISED 11/4/2016

Project number	Project Number
Date	Issue Date
Drawn by	Author
Checked by	Checker
A	\- 5

Scale

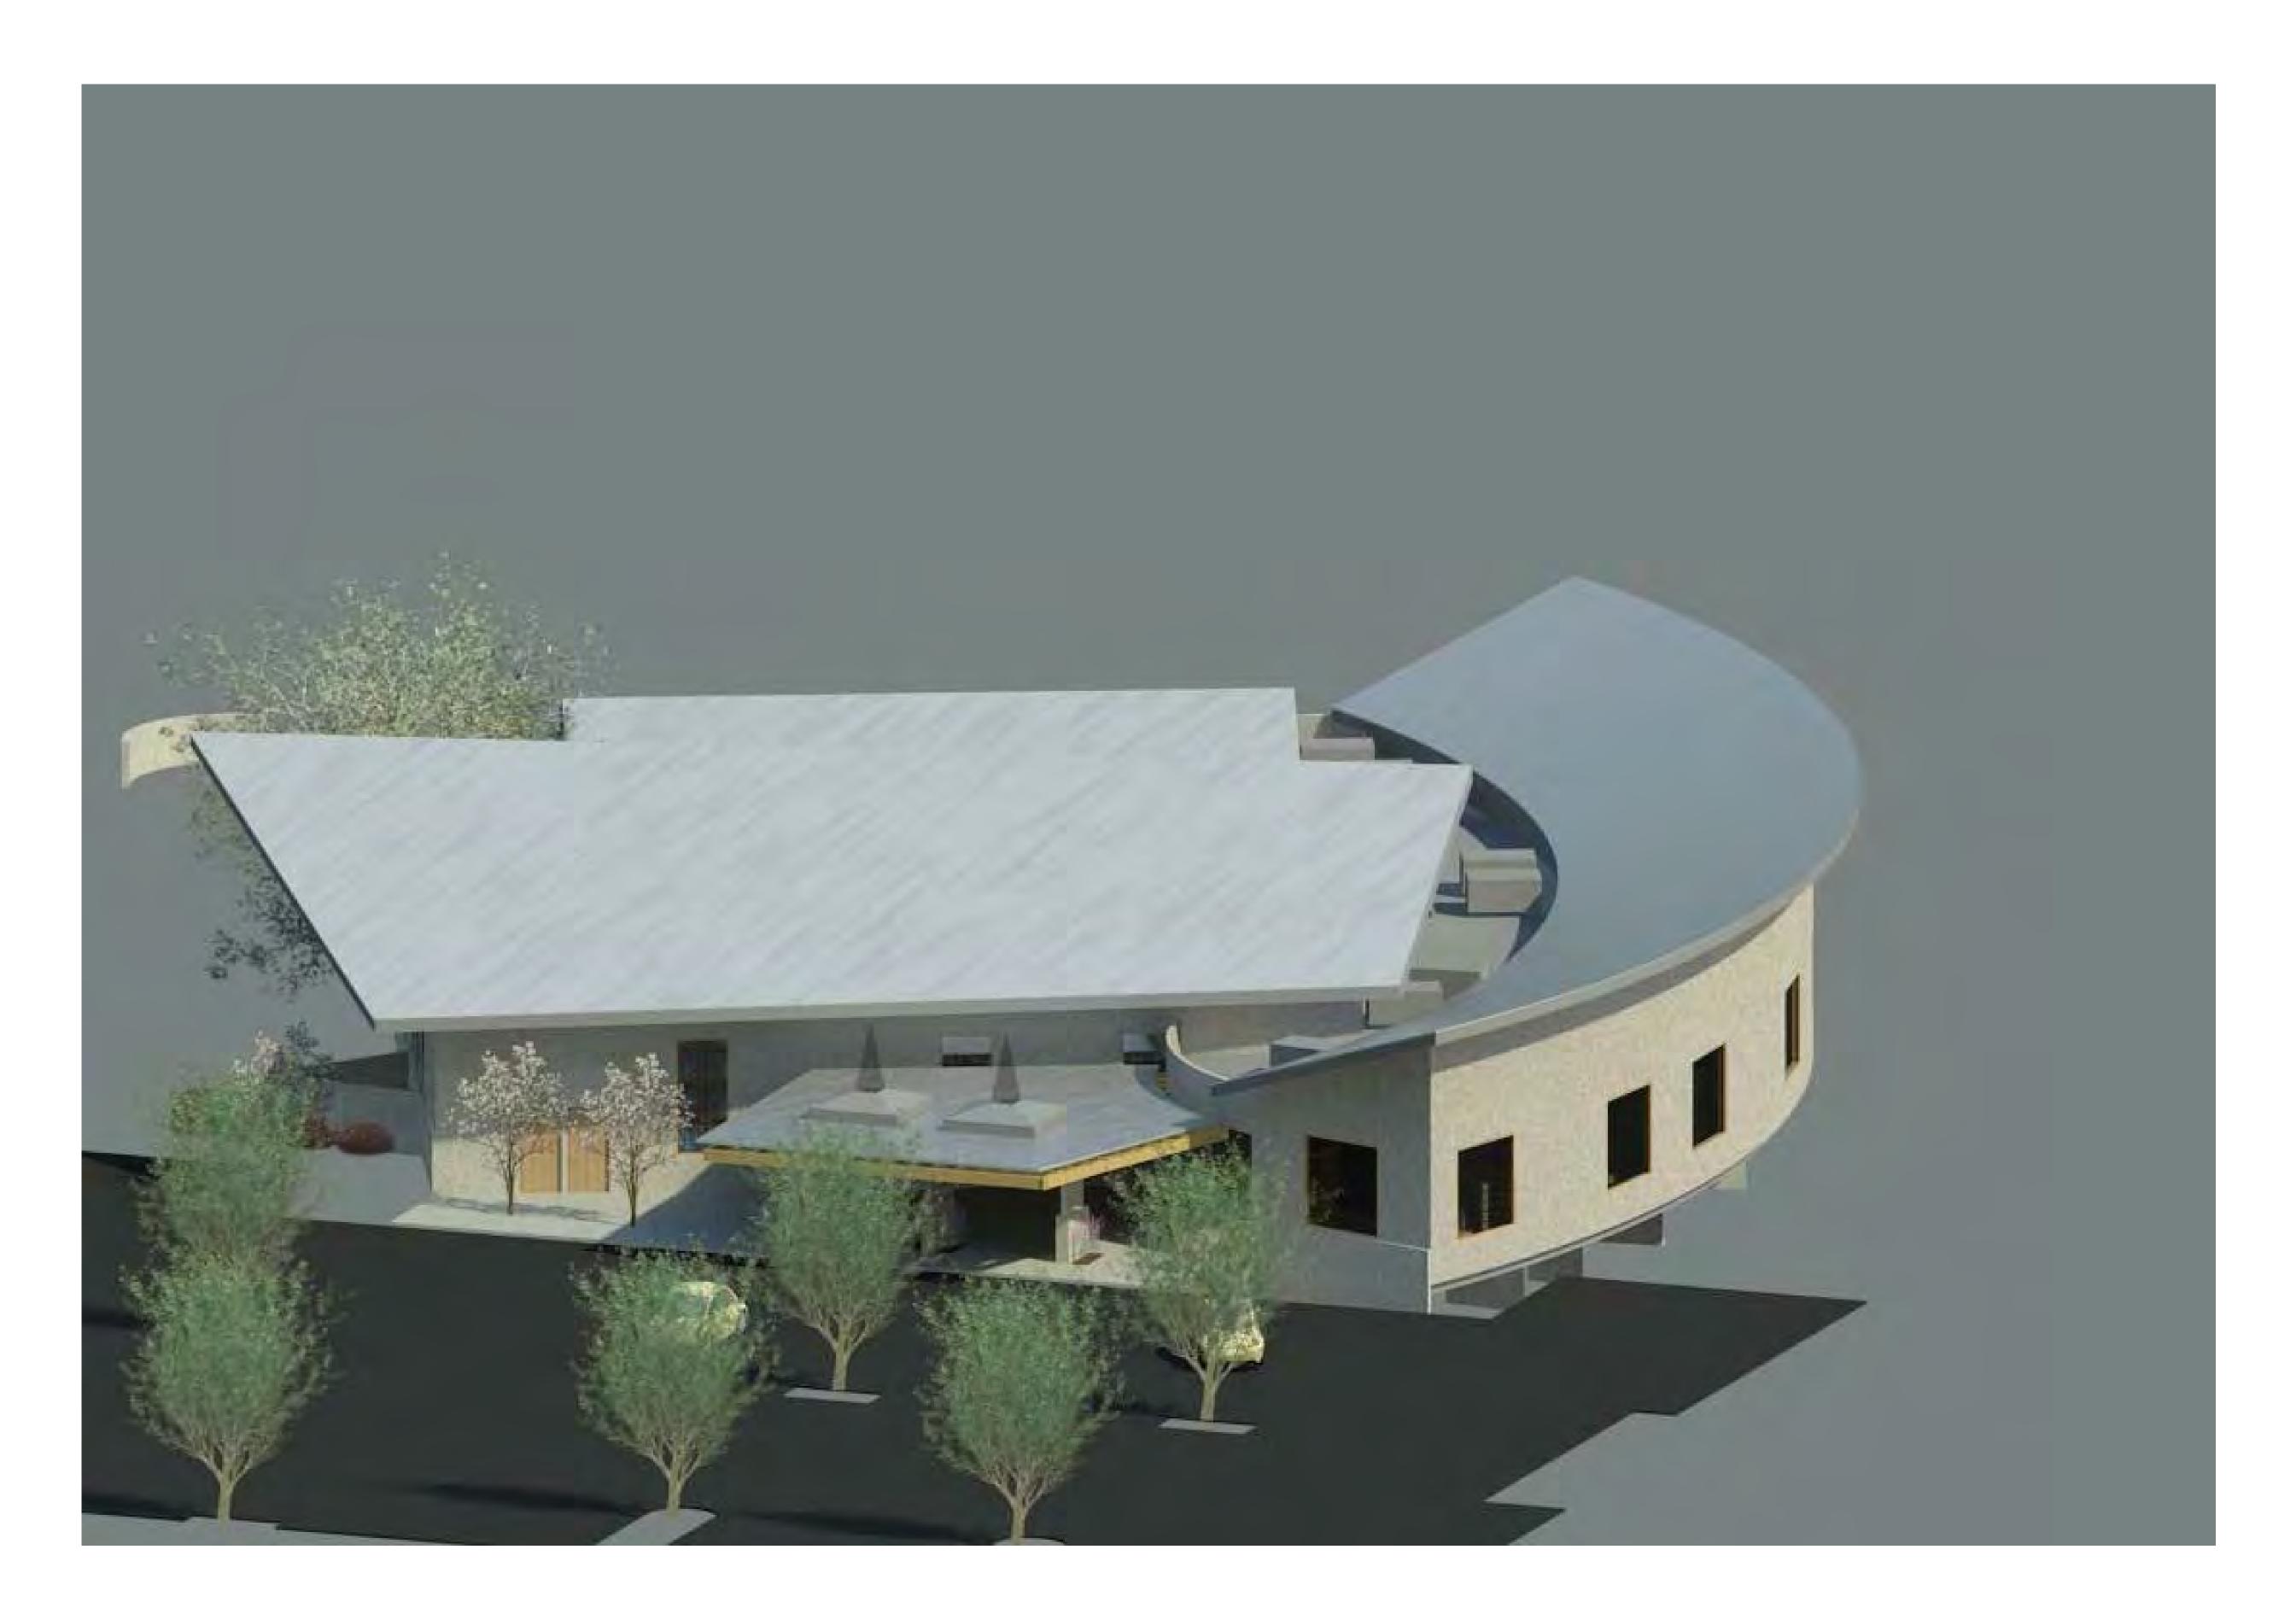



ELECTRICAL DESIGNER
ALI KAZEMI
11745 NEW MELONES CIRCLE
GOLD RIVER, CA 95670
Phone: (916) 397-2579
e-mail: alikazemi@sbcglobal.net
Electrical Consultant

No.	Description	Date

NEW CHURCH for NEW LIFE COMMUNITY SEVENTH-DAY ADVENTIST CHURCH NAPA COUNTY, CALIFORNIA

PERSPECTIVE LOOKING FROM THE NORTHEAST

REVISED 11/4/2016


A-6	
Checked by	Checker
rawn by	Author
ate	Issue Date
Project number	Project Number

12" = 1'-0"





ELECTRICAL DESIGNER
ALI KAZEMI
11745 NEW MELONES CIRCLE
GOLD RIVER, CA 95670
Phone: (916) 397-2579
e-mail: alikazemi@sbcglobal.net
Electrical Consultant

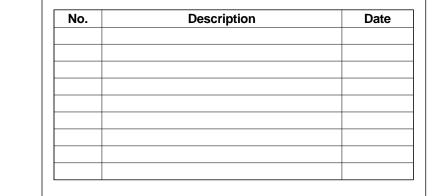


NEW CHURCH for NEW LIFE COMMUNITY SEVENTH-DAY ADVENTIST CHURCH NAPA COUNTY, CALIFORNIA


BUILDING SECTIONS


Project number	Project Number	
Date	Issue Date	
Drawn by	Author	
Checked by Checker		
Δ	\-7	

1/8" = 1'-0" Scale

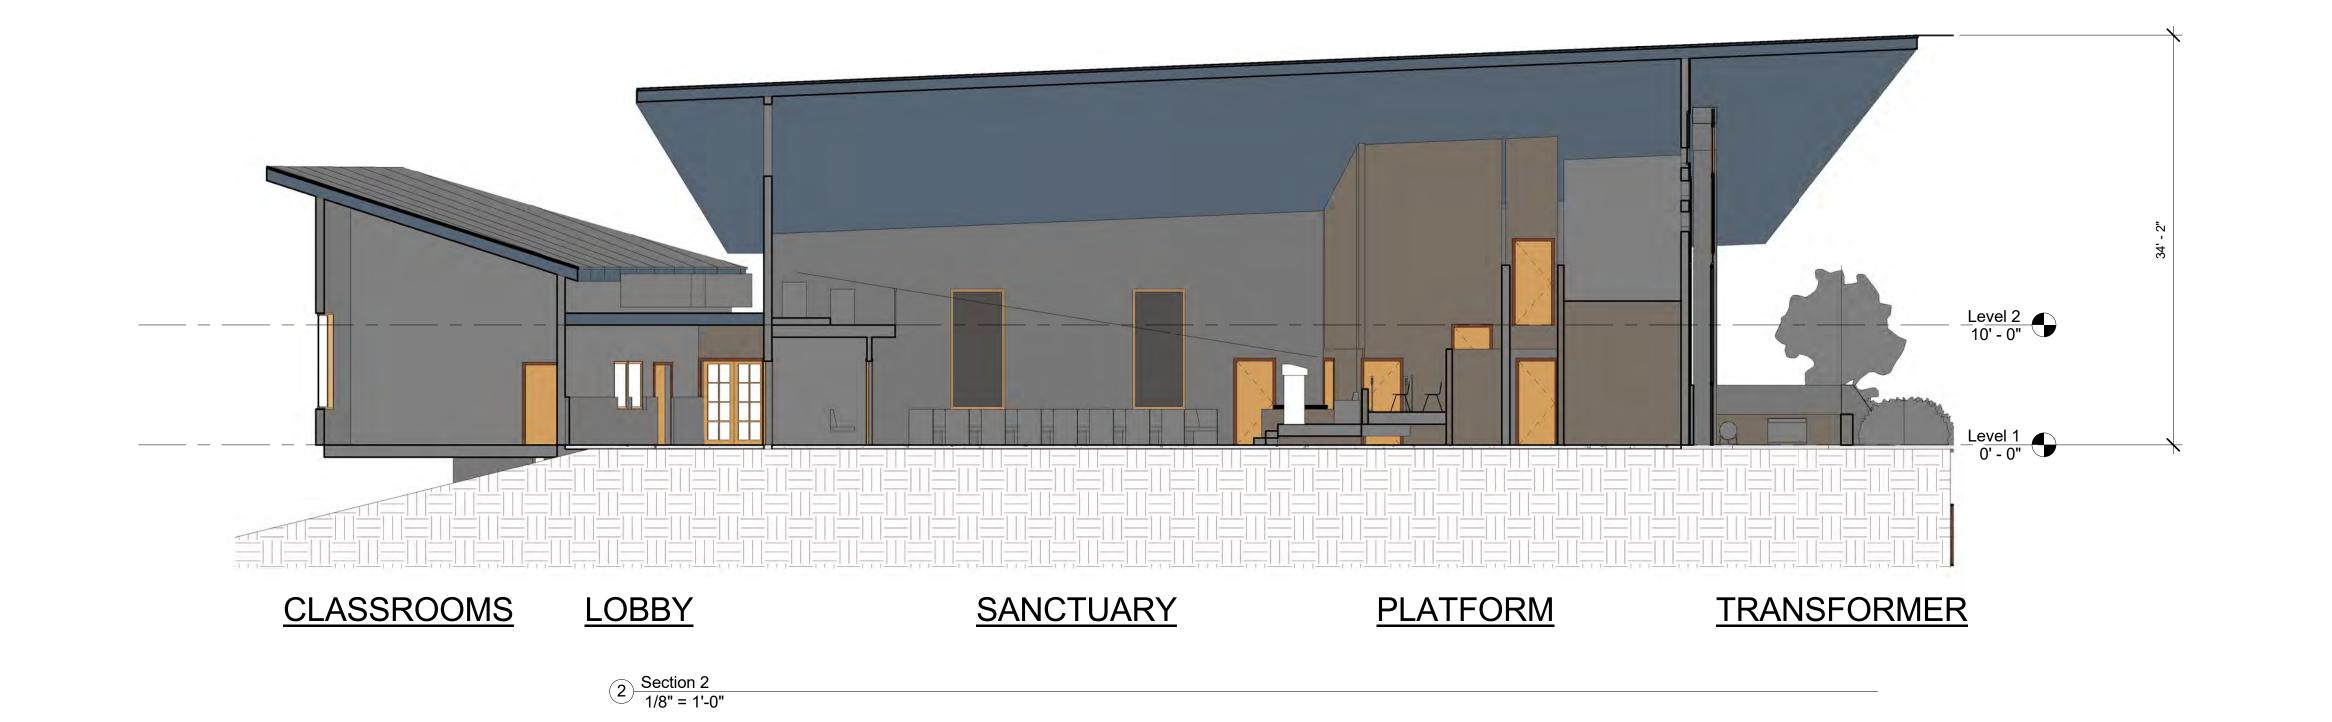



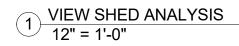

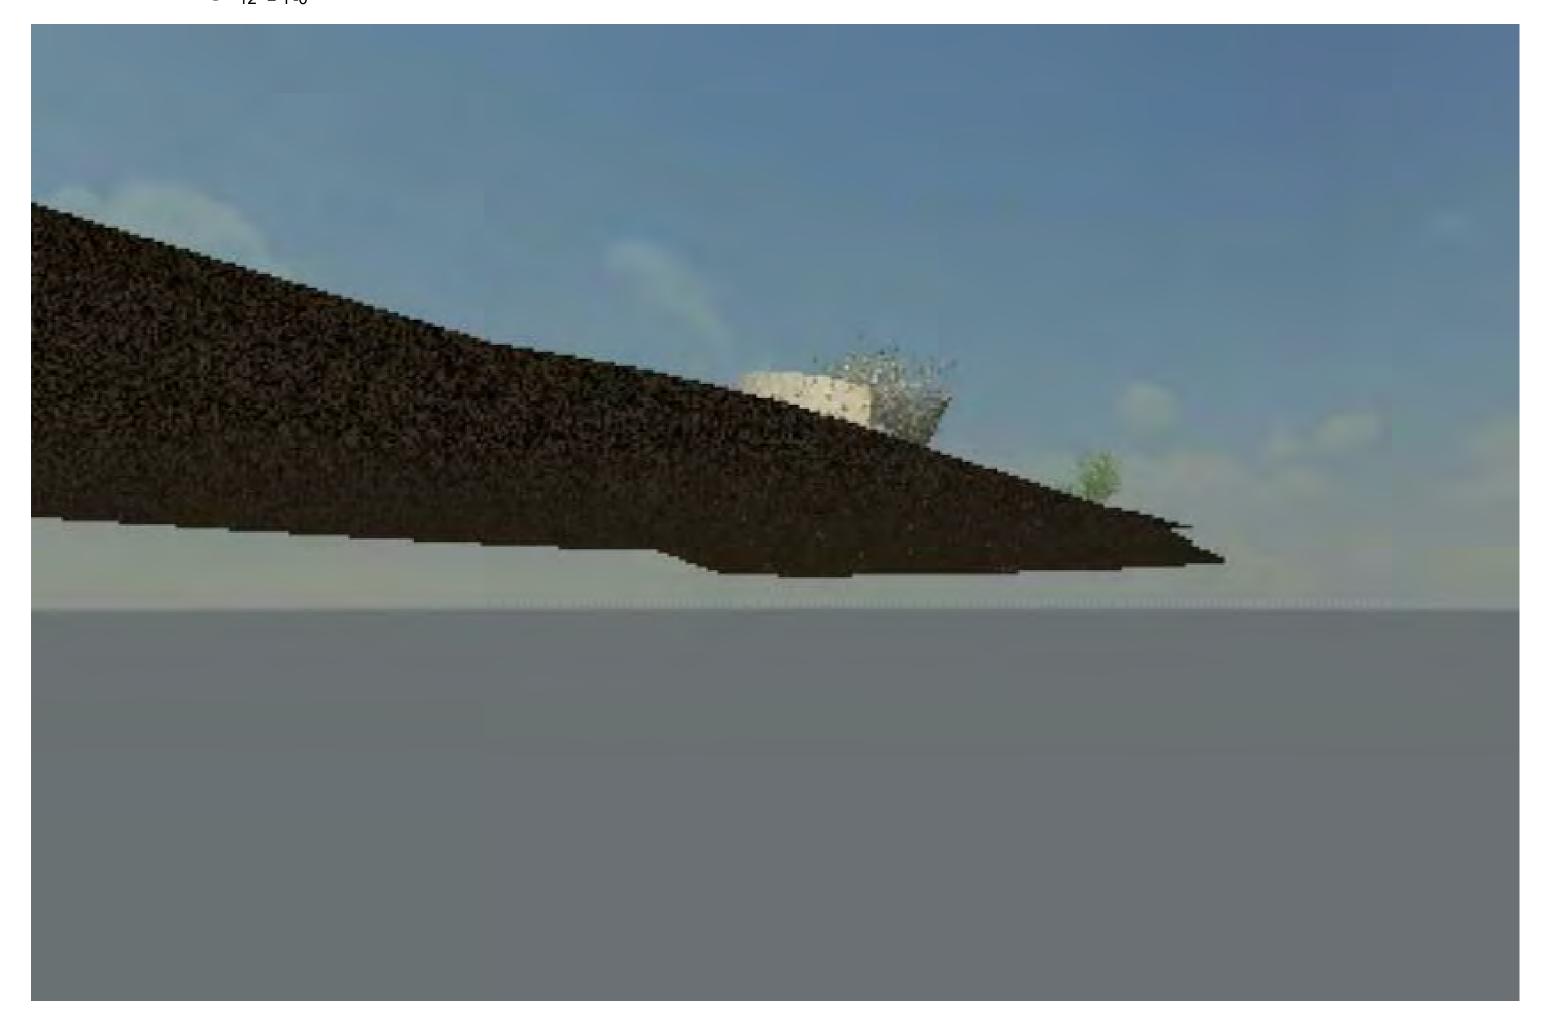



ELECTRICAL DESIGNER
ALI KAZEMI
11745 NEW MELONES CIRCLE
GOLD RIVER, CA 95670
Phone: (916) 397-2579
e-mail: alikazemi@sbcglobal.net
Electrical Consultant

No.	Description	Date

NEW CHURCH for NEW LIFE COMMUNITY SEVENTH-DAY ADVENTIST CHURCH NAPA COUNTY, CALIFORNIA

VIEWSHED ANALYSIS

REVISED 11/4/2016

Project number

Date

Drawn by

Checked by

Project Number


Issue Date

Author

Checked by

A-8Scale 12" = 1'-0"

2 VIEWSHED ANALYSIS 2 12" = 1'-0"

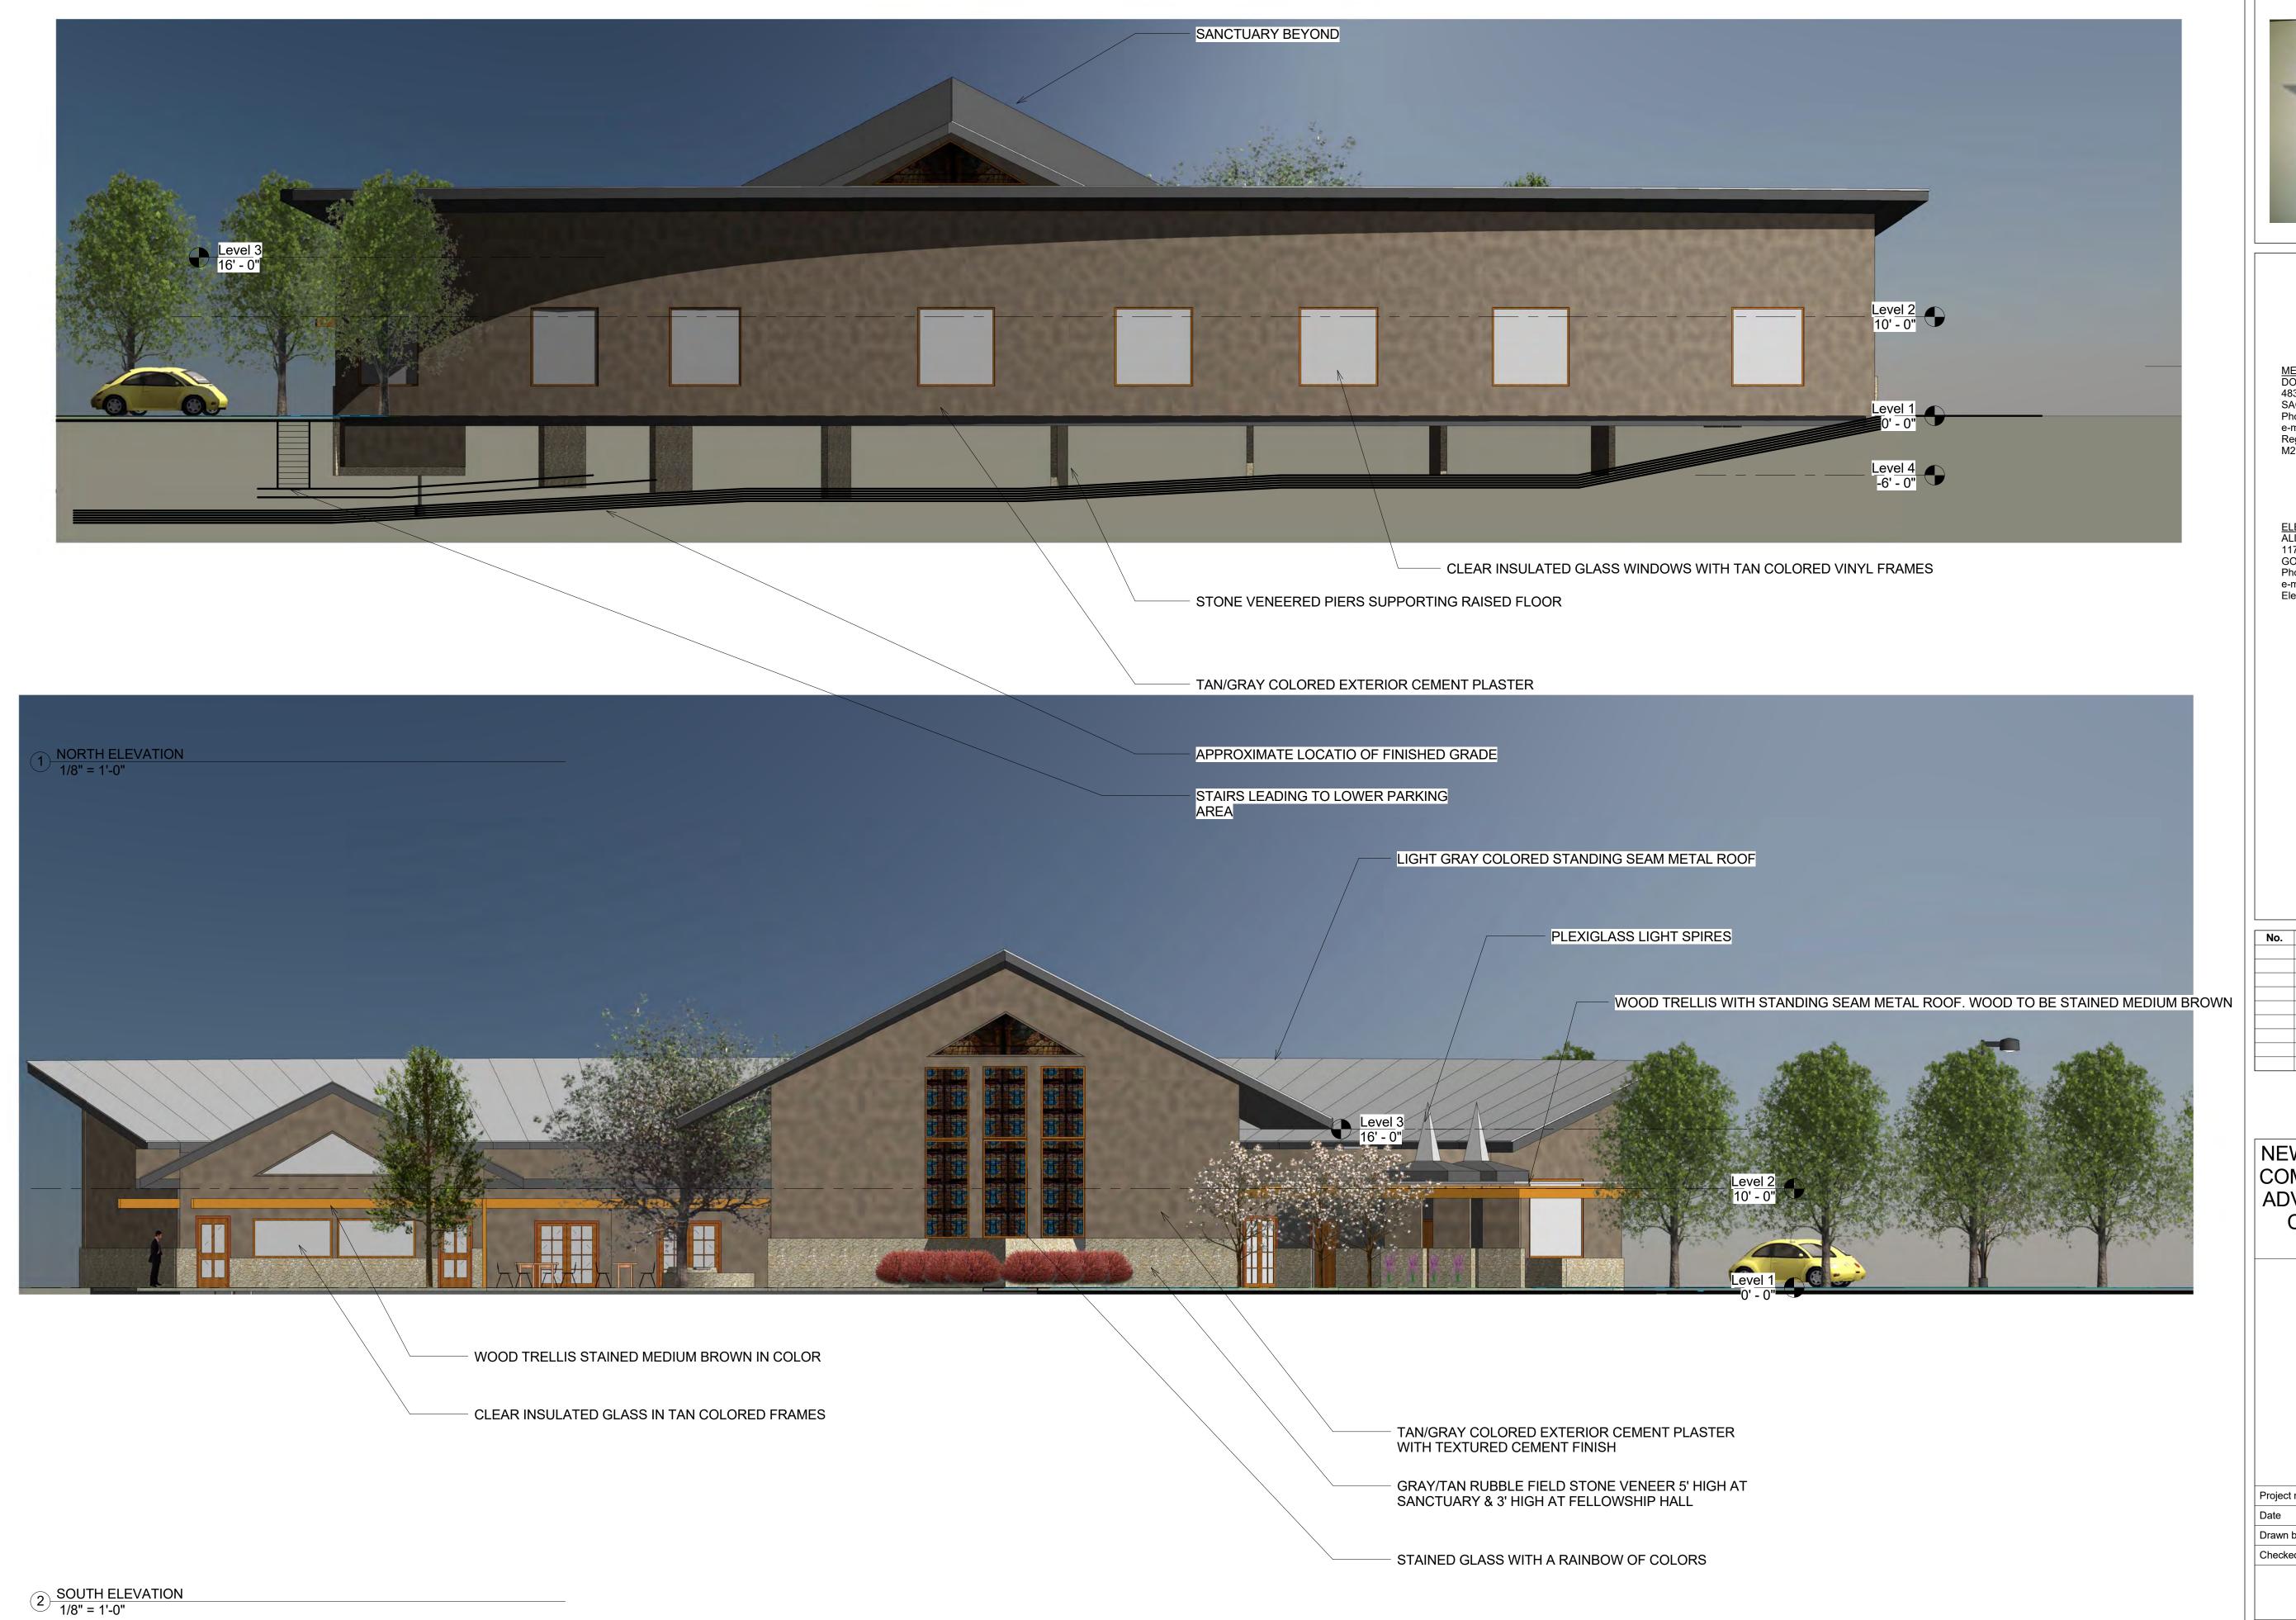



ELECTRICAL DESIGNER
ALI KAZEMI
11745 NEW MELONES CIRCLE
GOLD RIVER, CA 95670
Phone: (916) 397-2579
e-mail: alikazemi@sbcglobal.net
Electrical Consultant


No.	Description	Date

NEW CHURCH for NEW LIFE COMMUNITY SEVENTH-DAY ADVENTIST CHURCH NAPA COUNTY, CALIFORNIA

> BUILDING **ELEVATIONS**


Project number	Project Number	
Date	Issue Date	
Drawn by	Author	
Checked by	Checker	

A-9 1/8" = 1'-0" Scale

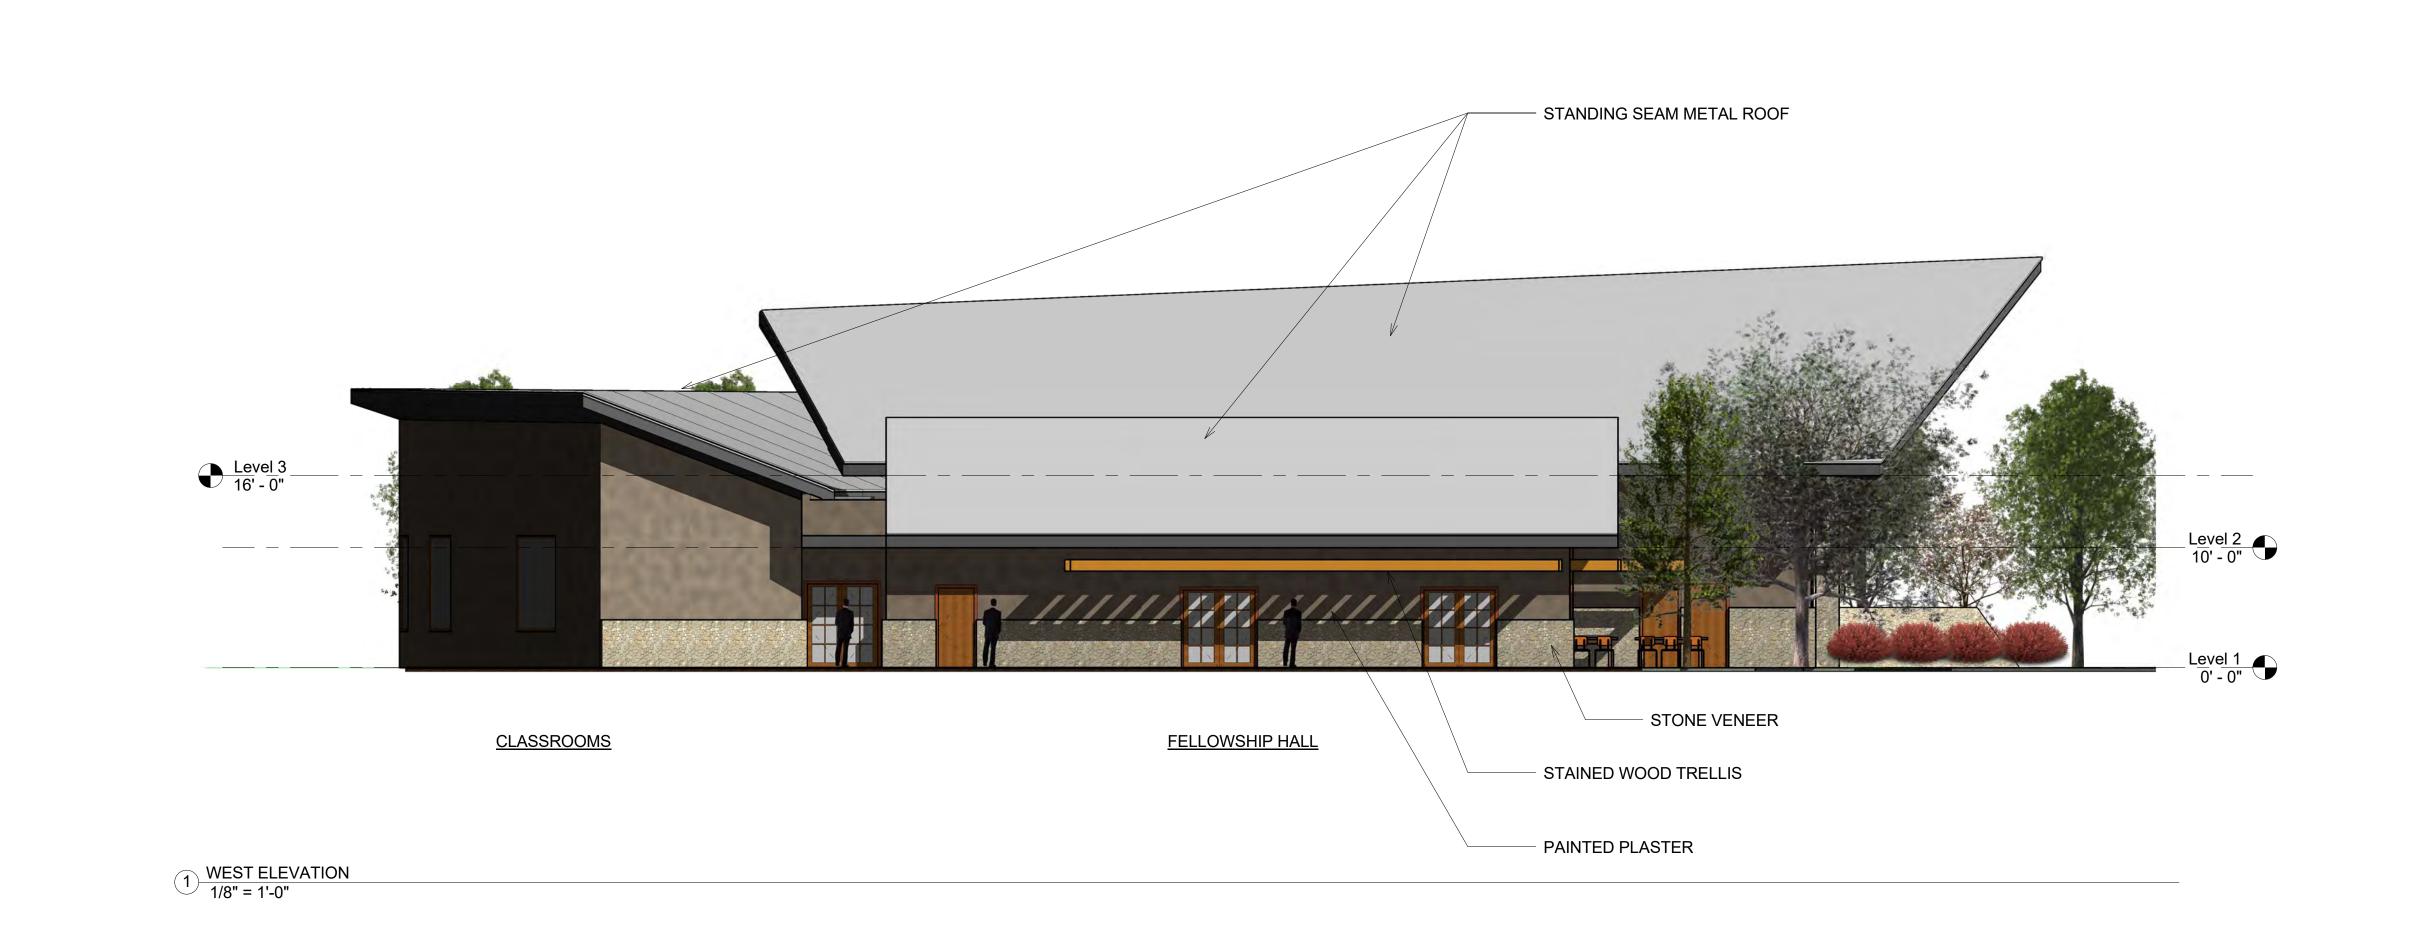



ELECTRICAL DESIGNER
ALI KAZEMI
11745 NEW MELONES CIRCLE
GOLD RIVER, CA 95670
Phone: (916) 397-2579
e-mail: alikazemi@sbcglobal.net
Electrical Consultant

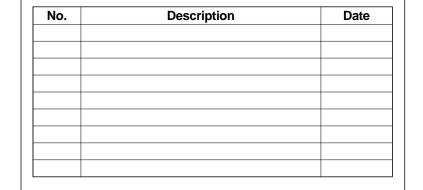

NEW CHURCH for NEW LIFE COMMUNITY SEVENTH-DAY ADVENTIST CHURCH NAPA COUNTY, CALIFORNIA

BUILDING **ELEVATIONS**

Project number	Project Number	
Date	Issue Date	
Drawn by	Author	
Checked by	Checker	

A-10 1/8" = 1'-0"


Scale



Description	Count	Family and Type	Mark	Comments	Botanical Name
NEW	1	RPC Shrub: COFFEEBERRY	S-1-1	5 GALLON	RHAMNUS CALIFORNICA
NEW	1	RPC Shrub: COFFEEBERRY	S-1-2	5 GALLON	RHAMNUS CALIFORNICA
NEW	1	RPC Shrub: COFFEEBERRY	S-1-3	5 GALLON	RHAMNUS CALIFORNICA
NEW	1	RPC Shrub: COFFEEBERRY	S-1-4	5 GALLON	RHAMNUS CALIFORNICA
NEW	1	RPC Shrub: COFFEEBERRY	S-1-5	5 GALLON	RHAMNUS CALIFORNICA
NEW	1	RPC Shrub: COFFEEBERRY	S-1-6	5 GALLON	RHAMNUS CALIFORNICA
NEW	1	RPC Shrub: COFFEEBERRY 4'	S-1-7	5 GALLON	RHAMNUS CALIFORNICA
NEW	1	RPC Shrub: COFFEEBERRY 4'	S-1-8	5 GALLON	RHAMNUS CALIFORNICA
NEW	1	RPC Shrub: FLANNELBUSH 4'	S-2-1	5 GALLON	FREMONTODENDRON CALIFORNICUM
NEW	1	RPC Shrub: FLANNELBUSH 4'	S-2-2	5 GALLON	FREMONTODENDRON
NEW	1	RPC Shrub: FLANNELBUSH 4'	S-2-3	5 GALLON	FREMONTODENDRON
NEW	1	RPC Shrub: FLANNELBUSH 4'	S-2-4	5 GALLON	CALIFORNICUM FREMONTODENDRON CALIFORNICUM
NEW	1	RPC Shrub: FLANNELBUSH 4'	S-2-5	5 GALLON	FREMONTODENDRON
NEW	1	RPC Shrub: FLANNELBUSH 4'	S-2-6	5 GALLON	CALIFORNICUM FREMONTODENDRON
NEW	1	RPC Shrub: FLANNELBUSH 4'	S-2-7	5 GALLON	CALIFORNICUM FREMONTODENDRON
NEW	1	RPC Shrub: FLANNELBUSH 4'	S-2-8	5 GALLON	FREMONTODENDRON
EXISTING	1	RPC Tree - Deciduous: BAY -	T-1	EXISTING	CALIFORNICUM
BAY EXISTING	1	25' RPC Tree - Deciduous: BAY -	T-2	TO REMAIN EXISTING	
BAY 24 NEW	1	RPC Tree - Deciduous:	T-3-1	TO REMAIN 15 GALLON	LAGERSTROEMIA INDICA
NEW	1	RPC Tree - Deciduous:	T-3-2	15 GALLON	'RED ROCKET' LAGERSTROEMIA INDICA
NEW	1	RPC Tree - Deciduous:	T-3-3	15 GALLON	'RED ROCKET' LAGERSTROEMIA INDICA
NEW	1	RPC Tree - Deciduous: RED	T-4-1	15 GALLON	'RED ROCKET' ACER RUBRUM
NEW	1	MAPLE - 25' RPC Tree - Deciduous: RED	T-4-2	15 GALLON	ACER RUBRUM
NEW	1	MAPLE - 25' RPC Tree - Deciduous: RED	T-4-3	15 GALLON	ACER RUBRUM
NEW	1	MAPLE - 25' RPC Tree - Deciduous: RED	T-4-4	15 GALLON	ACER RUBRUM
NEW	1	MAPLE - 25' RPC Tree - Deciduous: RED	T-4-5	15 GALLON	ACER RUBRUM
NEW	1	MAPLE - 25' RPC Tree - Deciduous: RED	T-4-6	15 GALLON	ACER RUBRUM
NEW	1	MAPLE - 25' RPC Tree - Deciduous: RED	T-4-7	15 GALLON	ACER RUBRUM
NEW	1	MAPLE - 25' RPC Tree - Deciduous: RED	T-4-8	15 GALLON	ACER RUBRUM
NEW	1	MAPLE - 25' RPC Tree - Deciduous: RED	T-4-9	15 GALLON	ACER RUBRUM
NEW	1	MAPLE - 25' RPC Tree - Deciduous: RED	T-4-10	15 GALLON	
NEW	1	MAPLE - 25' RPC Tree - Deciduous: RED	t-4-11	15 GALLON	ACER RUBRUM
NEW	1	MAPLE - 25' RPC Tree - Deciduous: RED	T-4-12	15 GALLON	
NEW	1	MAPLE - 25' RPC Tree - Deciduous: RED	T-4-13	15 GALLON	
EXISTING APPLE	1	MAPLE - 25' RPC Tree - Deciduous: APPLE - 15'	T-5-1	EXISTING TO BE	
EXISTING	1	RPC Tree - Deciduous: APPLE	T-5-2	REMOVED EXISTING	
APPLE	•	- 15'	. 52	TO BE REMOVED	

GENERAL NOTES:

- THE IRRIGATION SYSTEM SHALL BE A DRIP SYSTEM THROUGHOUT. THE LANDSCAPE IRRIGATION SYSTEM SHALL NOT EXCEED THE WATER BUDGET AS DEFINED
- BY THE CALIFORNIA DEPARTMENT OF WATER RESOURCES MODEL WATER EFFICIENT LANDSCAPE ORDINANCE OR LOCAL ORDINANCE WHICH EVER IS MORE STRICT.
- THERE SHALL BE A SEPARATE WATER METER FOR THE LANDSCAE IRRIGATION SYSTEM.
- THE IRRIGATION CONTROLLER SHALL BE WEATHER OR SOIL-MOISTURE BASED.
- THE ENTIRE IRRIGATION SYSTEM SHALL COMPLY WITH THE CALIFORNIA GREEN BUILDINGS
- STANDARD CODE, SECTION 5.304.
- DOUBLE PARKING STALLS EQUAL 34 = 6 TREES REQUIRED; 22 SINGLE PARKING STALLS = 7
- TREES REQUIRED. GRAND TOTAL 13 TREES REQUIRED AND PROVIDED.
- 7. SANCTUARY AND ENTRY ROOF IS SHOWN TRANSPARENT SO THAT LANDSCAPING BELOW IS VISIBLE.

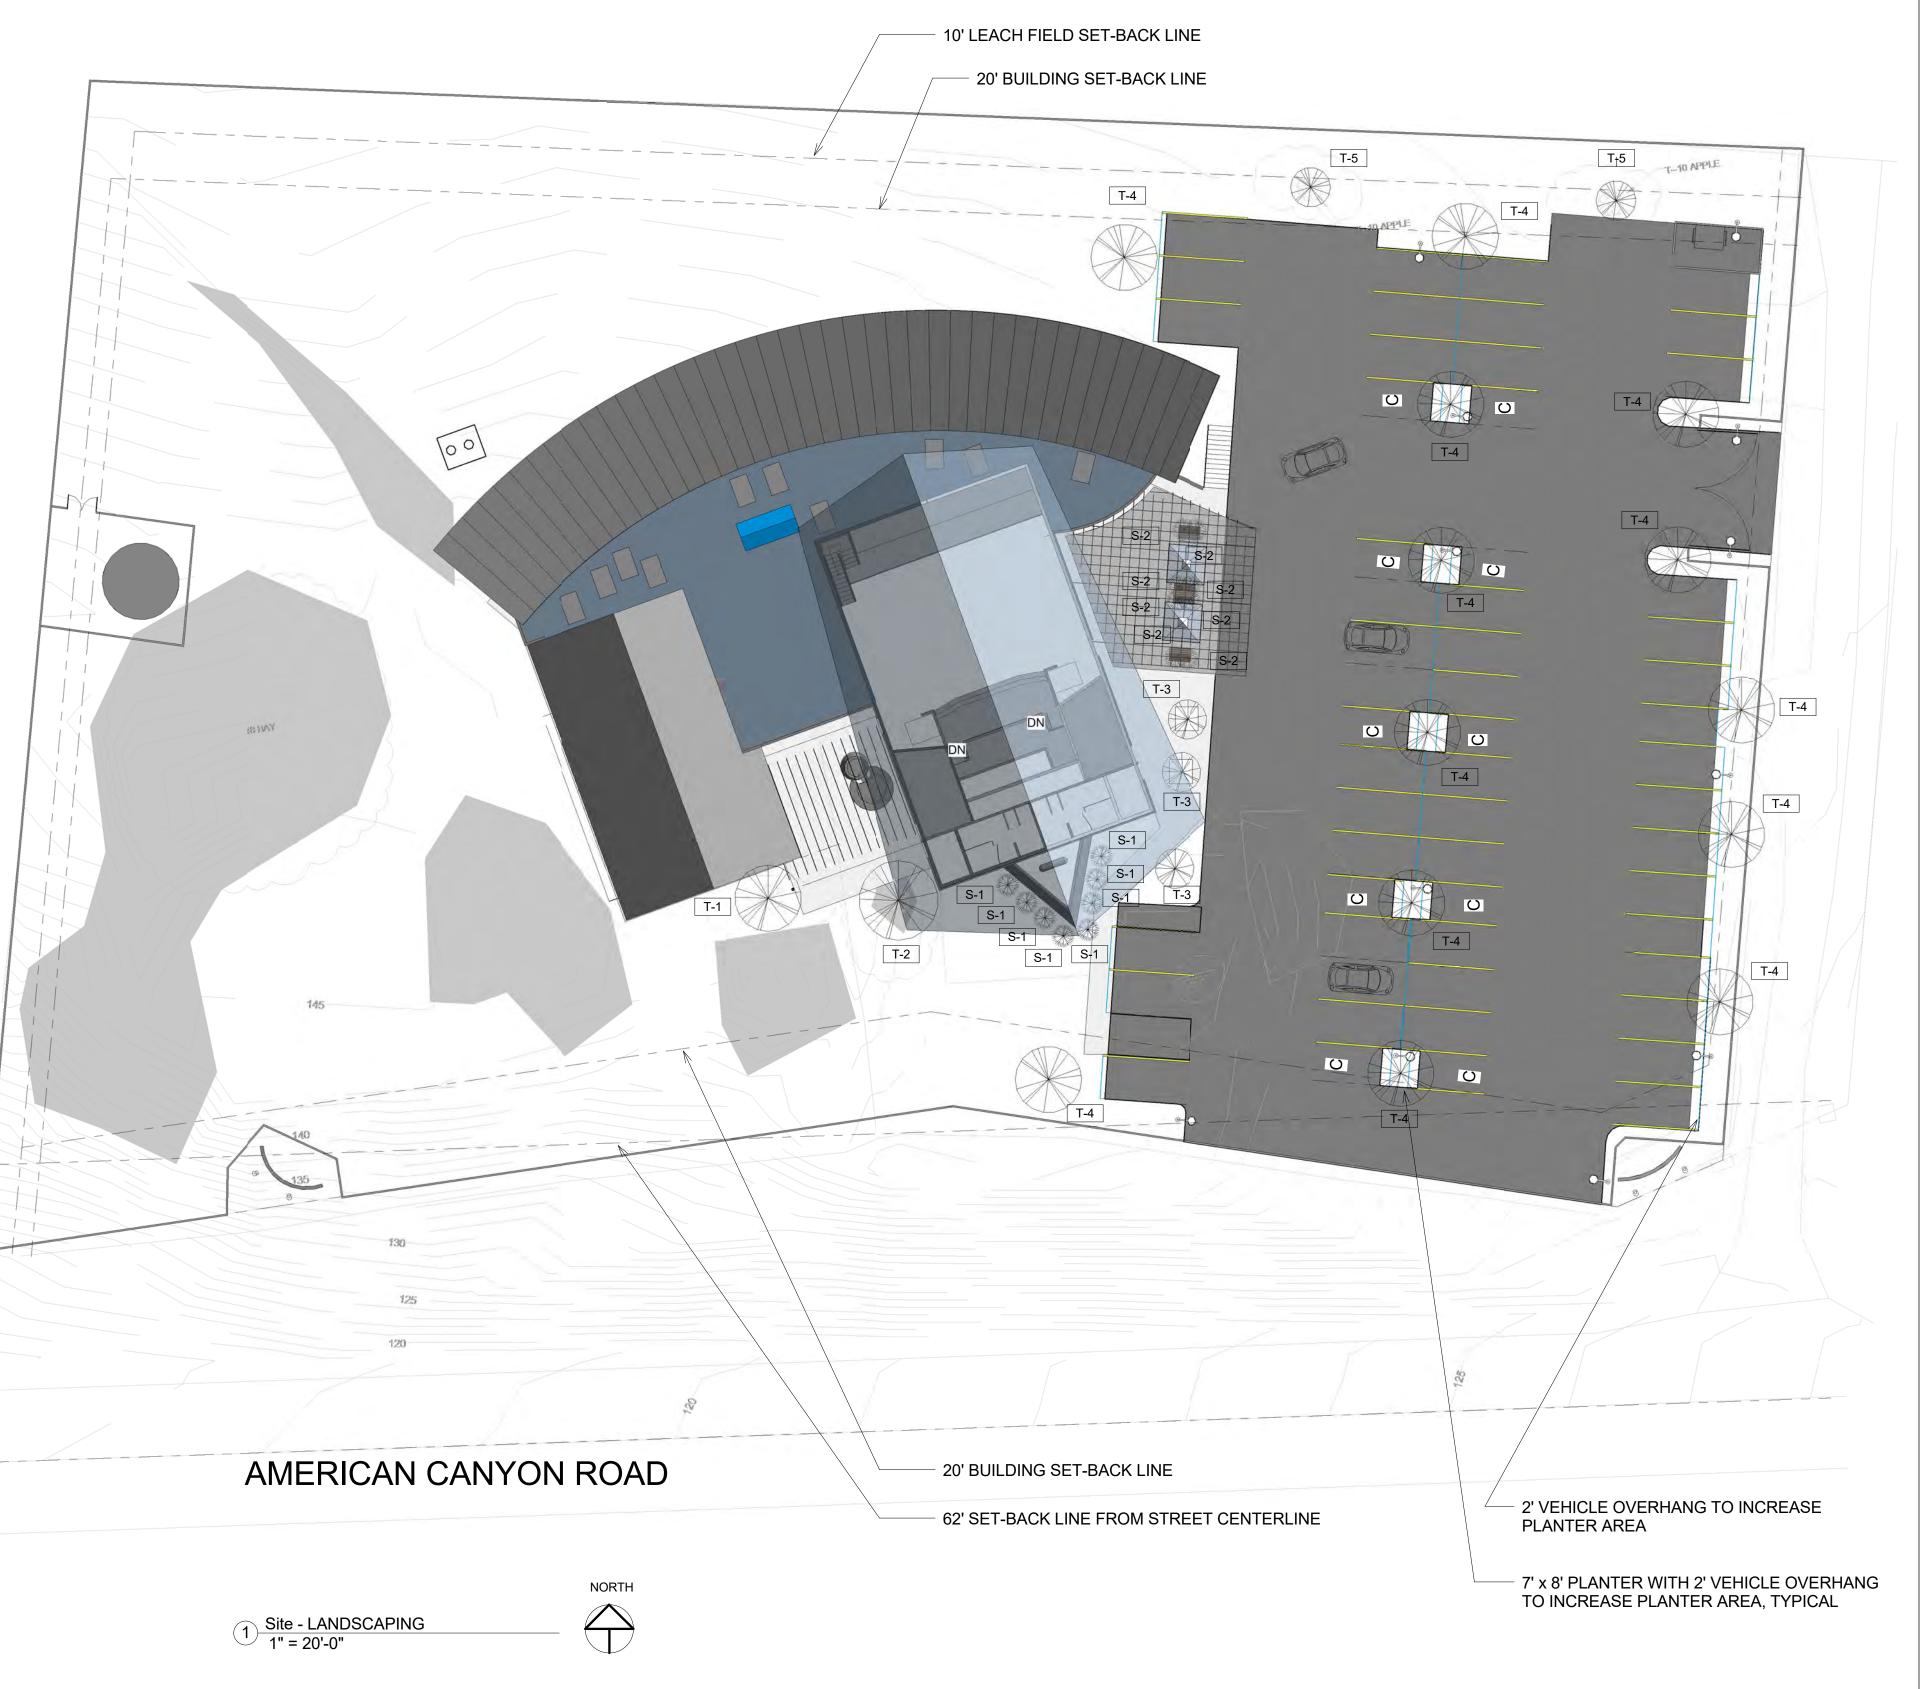



MECHANICAL ENGINEER DOUGLAS LOVELL, PE 4833 GRADUATES LANE SACRAMENTO, CA 95841 Phone: (916) 484-7779
e-mail: dlovell49@hotmail.com
Registered Mechanical Engineer
M25745 Expiration date 3/31/2017

ELECTRICAL DESIGNER
ALI KAZEMI
11745 NEW MELONES CIRCLE
GOLD RIVER, CA 95670
Phone: (916) 397-2579
e-mail: alikazemi@sbcglobal.net
Electrical Consultant

No.	Description	Date

NEW CHURCH for NEW LIFE COMMUNITY SEVENTH-DAY ADVENTIST CHURCH NAPA COUNTY, CALIFORNIA

LANDSCAPE PLAN

REVISED 11/4/2016


Project Number Project number Issue Date Drawn by Author Checker Checked by

L-Scale

1" = 20'-0"

STANDING SEAM METAL ROOF STAINED GLASS WINDOWS IN A VARIETY OF STUCCO COLORS FINISH STONE VENEER STAINED WOOD TRELLIS COLORED WINDOW FRAMES 1 ELEVATION FOR COLOR BOARD 1/8" = 1'-0"

NEW CHURCH for NEW LIFE COMMUNITY SEVENTH-DAY ADVENTIST CHURCH NAPA COUNTY, CALIFORNIA

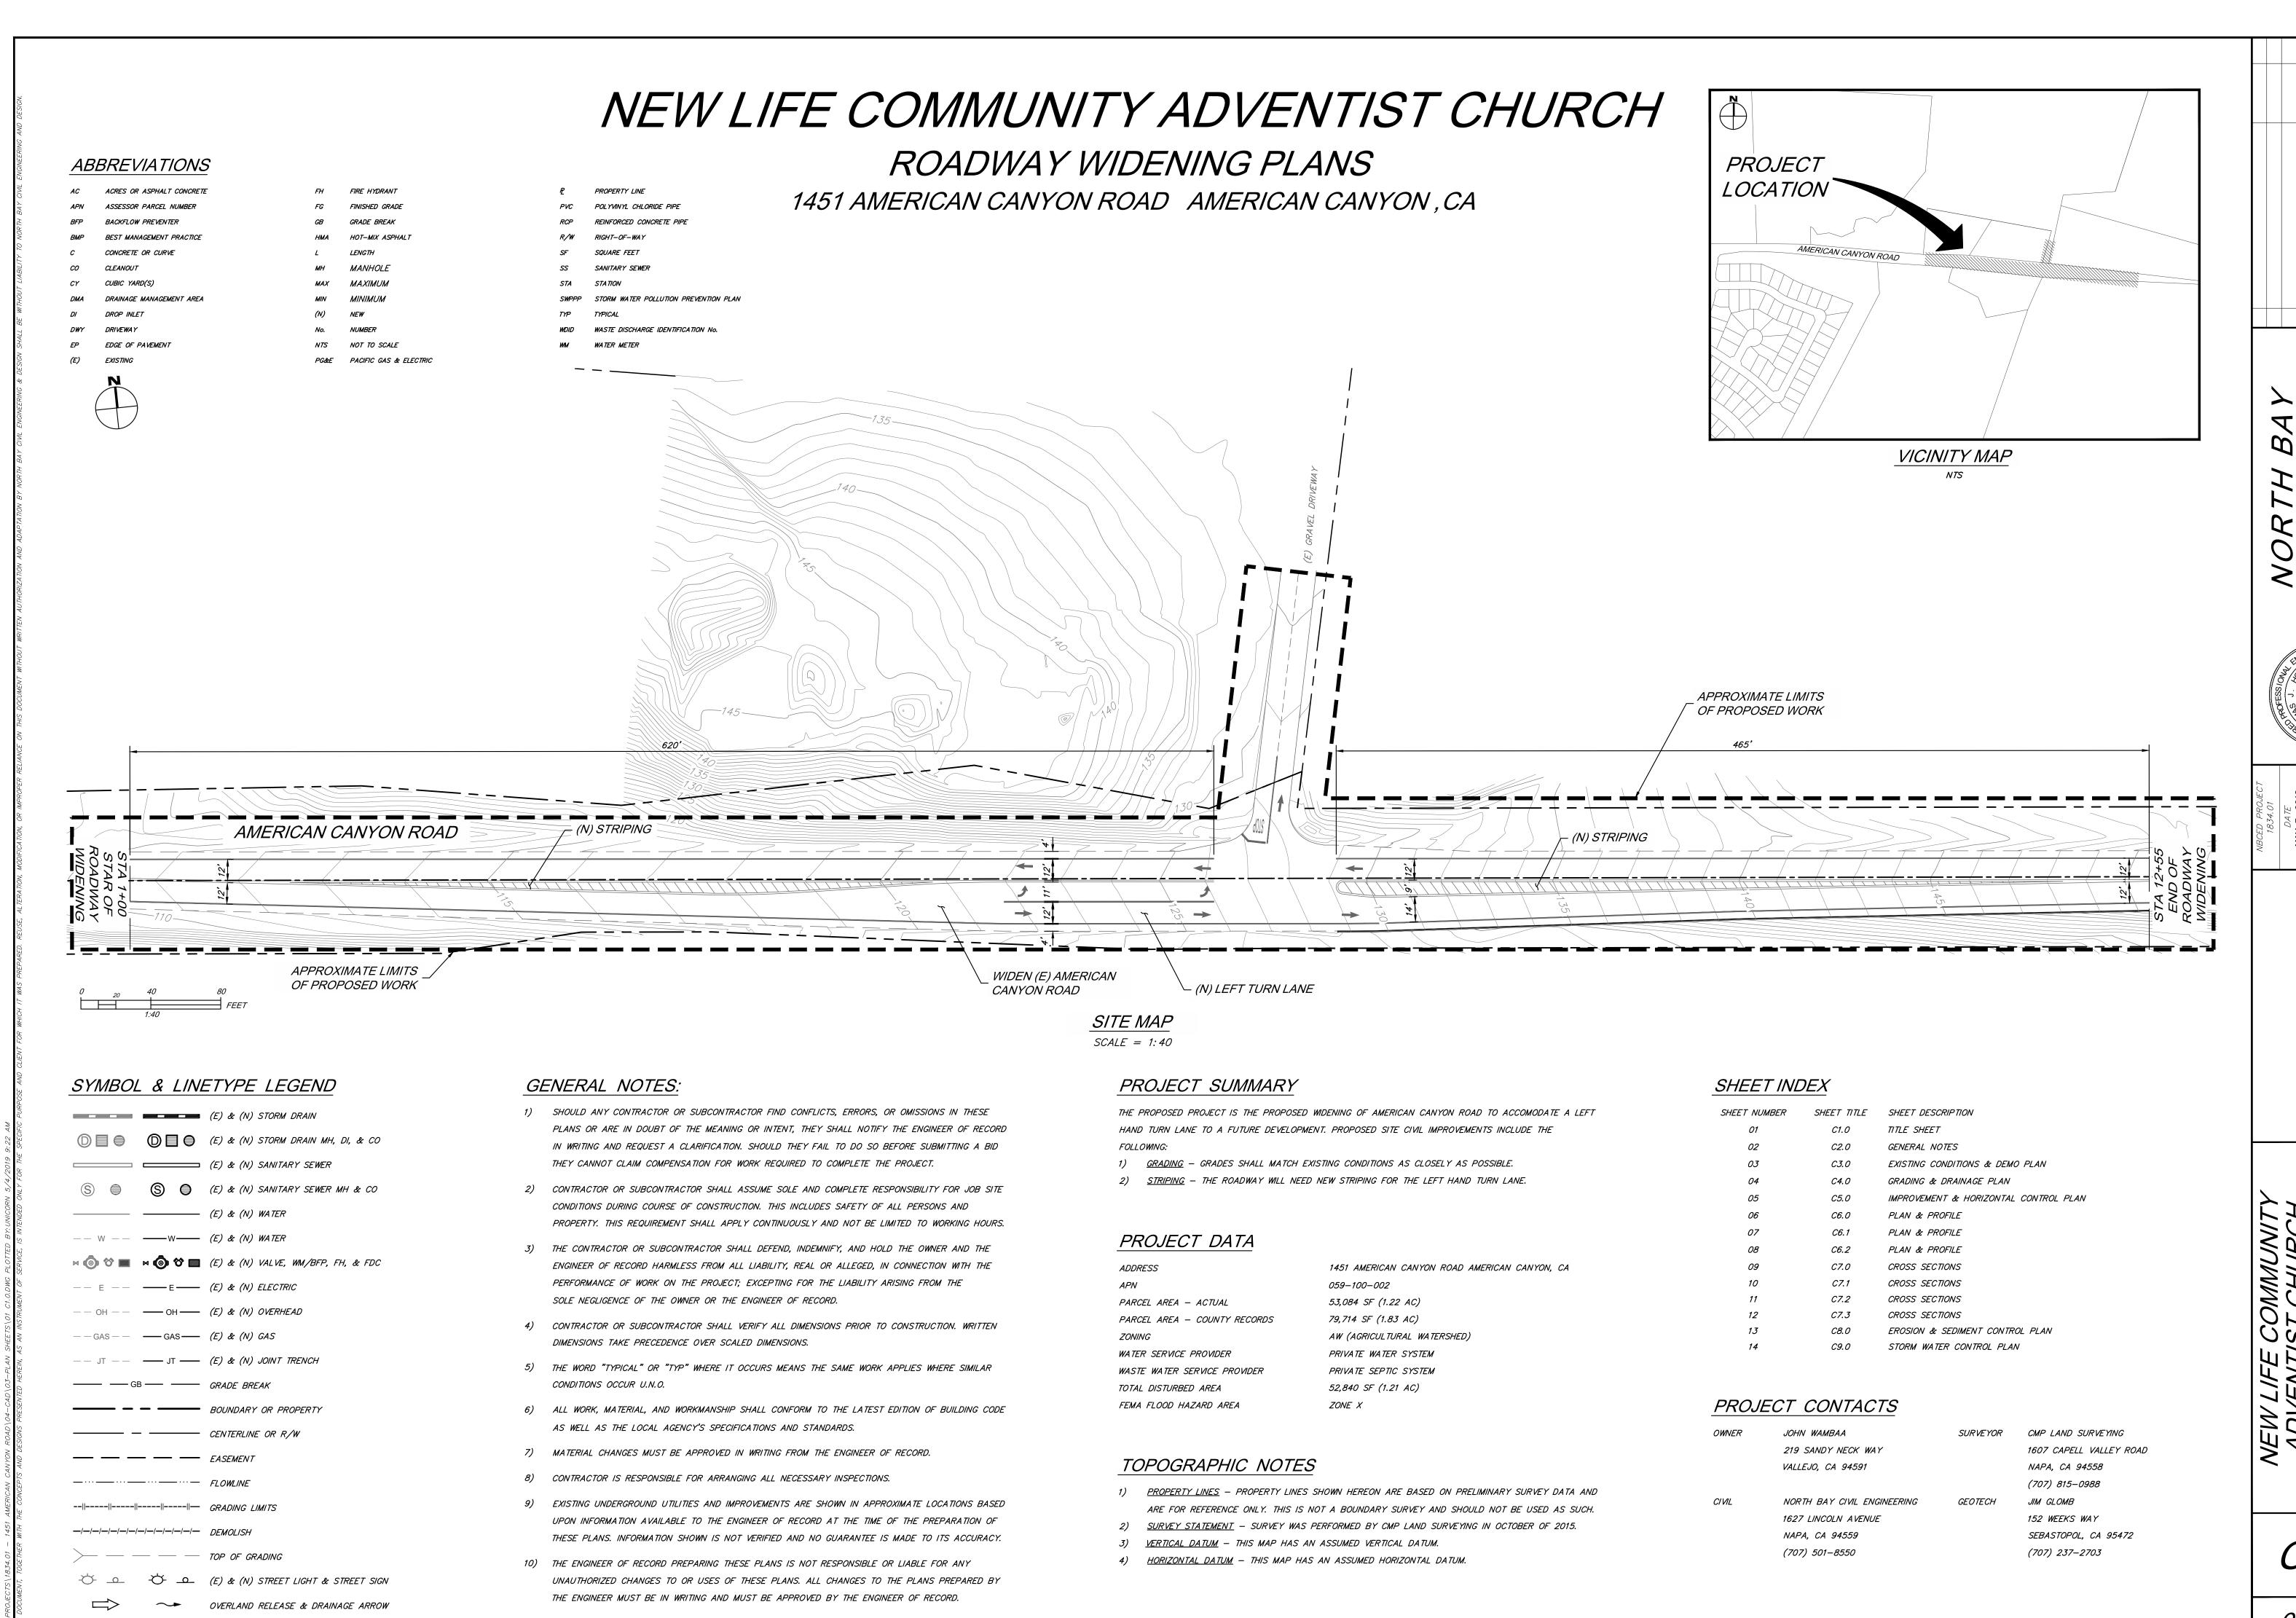

COUNTY OF NAPA GENERAL CONSTRUCTION NOTES

- 1) ALL WORKMANSHIP AND MATERIALS FOR BOTH ON-SITE AND OFF-SITE IMPROVEMENTS SHALL CONFORM TO THE ADOPTED NAPA COUNTY
 SUBDIVISION ROAD AND STREET STANDARDS (REVISED AUGUST 9, 2011) OR LATEST EDITION, AND/OR THE LATEST EDITION OF THE STATE OF
 CALIFORNIA STANDARD SPECIFICATIONS AND STANDARD PLANS. THE ON-SITE IMPROVEMENTS SHALL BE INSPECTED BY THE PUBLIC WORKS INSPECTOR.
- 2) CONTRACTOR SHALL BE FULLY RESPONSIBLE FOR BEING FAMILIAR WITH THE PROVISIONS AND REQUIREMENTS CONTAINED IN THE COUNTY OF NAPA STANDARD SPECIFICATIONS. CONTRACTOR SHALL HAVE A COPY AVAILABLE AT THE JOB SITE AT ALL TIMES.
- 3) CONTRACTOR SHALL NOTIFY ALL PUBLIC OR PRIVATE UTILITY COMPANIES 48 HOURS PRIOR TO COMMENCEMENT OF WORK ADJACENT TO EXISTING UTILITY LINES UNLESS ENCROACHMENT PERMIT SPECIFIES OTHERWISE.
- 4) CONTRACTOR SHALL PROVIDE EMERGENCY TELEPHONE NUMBERS TO THE COUNTY OF NAPA POLICE DEPARTMENT, FIRE DEPARTMENT, PLANNING
 DEPARTMENT, BUILDING DEPARTMENT, AND ENVIRONMENTAL SERVICE DEPARTMENT AND KEEP THEM INFORMED DAILY REGARDING STREETS UNDER
 CONSTRUCTION AND DETOURS. DETOURS SHALL NOT BE PERMITTED UNLESS APPROVED IN WRITING BY THE PLANNING, BUILDING, AND ENVIRONMENTAL
 DEPARTMENTS.
- 5) CONTRACTOR SHALL BE RESPONSIBLE FOR THE VERIFICATION OF ALL EXISTING UTILITIES IN THE FIELD. LOCATIONS OF UTILITIES AND UNDERGROUND FACILITIES SHOWN ARE APPROXIMATE AND FOR GENERAL INFORMATION ONLY.
- 6) CONTRACTOR SHALL PROVIDE AND MAINTAIN SUFFICIENT BARRICADES TO PROVIDE FOR THE SAFETY OF THE GENERAL PUBLIC TO THE SATISFACTION OF THE PUBLIC WORKS DIRECTOR.
- 7) ALL MATERIALS SHALL BE FURNISHED AND INSTALLED BY THE CONTRACTOR UNLESS OTHERWISE NOTED.
- 8) CONTRACTOR SHALL CONFORM TO THE THE EXISTING STREETS, SURROUNDING LANDSCAPE, AND OTHER IMPROVEMENTS WITH A SMOOTH TRANSITION IN PAVING, CURBS, GUTTERS, SIDEWALKS, GRADING, ETC. AND TO AVOID ANY ABRUPT OR APPARENT CHANGES IN GRADES OR CROSS SLOPES, LOW SPOTS, OR HAZARDOUS CONDITIONS.
- 9) CONTRACTOR SHALL COORDINATE ALL NECESSARY UTILITY RELOCATIONS, IF REQUIRED, WITH THE APPROPRIATE UTILITY COMPANIES.
- 10) CONTRACTOR SHALL CONTACT THE COUNTY OF NAPA ENGINEER'S OFFICE TO ARRANGE A PRE-PROJECT CONFERENCE FOR THE PURPOSE OF REVIEWING JOB REQUIREMENTS AND COUNTY PROCEDURES.
- 11) CONTRACTOR AGREES THAT HE SHALL ASSUME SOLE AND COMPLETE RESPONSIBILITY FOR JOB SITE CONDITIONS DURING THE COURSE OF CONSTRUCTION OF THIS PROJECT, INCLUDING SAFETY OF ALL PERSONS AND PROPERTY. THIS REQUIREMENT SHALL APPLY CONTINUOUSLY AND NOT BE LIMITED TO NORMAL WORKING HOURS. THE CONTRACTOR SHALL DEFEND, INDEMNIFY AND HOLD THE OWNERS AND THE ENGINEER HARMLESS FROM ALL LIABILITY, REAL OR ALLEGED, IN CONNECTION WITH THE PERFORMANCE OF WORK ON THE PROJECT; EXCEPTING FOR LIABILITY ARISING FROM THE SOLE NEGLIGENCE OF THE OWNERS OR THE ENGINEER.
- 12) SHOULD ANY CONTRACTOR OR SUBCONTRACTOR FIND ANY DEFICIENCIES, ERRORS, CONFLICTS OR OMISSIONS IN THESE PLANS AND SPECIFICATIONS
 OR SHOULD HE BE IN DOUBT AS TO THEIR MEANING OR INTENT, HE SHALL NOTIFY THE ENGINEER FOR A WRITTEN CLARIFICATION, ADDENDUM, ETC.
 SHOULD HE FAIL TO DO SO BEFORE SUBMITTING A PROPOSAL HE CANNOT CLAIM ADDITIONAL COMPENSATION FOR WORK REQUIRED TO COMPLETE THE PROJECT.
- 13) IF THERE IS A CONFLICT BETWEEN WRITTEN AND SCALED DIMENSIONS, NOTIFY THE ENGINEER AND OBTAIN A CLARIFICATION. NO DEVIATIONS OR SUBSTITUTIONS SHALL BE ALLOWED WITHOUT OBTAINING WRITTEN APPROVAL FROM THE ENGINEER.
- 14) PRIOR TO THE COMMENCEMENT OF CONSTRUCTION, THE CONTRACTOR SHALL SECURE CONSTRUCTION PERMITS FROM THE COUNTY OF NAPA AND OTHER AGENCIES AS NECESSARY AND PAY ALL FEES THEREFORE.
- 15) ON WEEK PRIOR TO ANY EXCAVATION IN EXISTING STREET AREAS, THE CONTRACTOR SHALL CONTACT COUNTY OF NAPA PUBLIC WORKS DEPARTMENT, UTILITY OWNERS, AND OTHER AGENCIES THAT ARE POTENTIALLY IMPACTED BY THE PROPOSED PROJECT FOR MARKING THE LOCATION OF THEIR RESPECTIVE FACILITIES. COSTS OF REPAIRING DAMAGES CAUSED BY THE CONTRACTOR SHALL BE BORNE BY THE CONTRACTOR.
- 16) UNDERGROUND LINES, IF ANY, WERE OBTAINED FROM RESPECTIVE UTILITY COMPANIES, THEREFORE, NO WARRANTY, EXPRESSED OR IMPLIED, IS MADE AS TO THE COMPLETENESS OR CORRECTNESS OF THEIR LOCATION.
- 17) ALL STATIONS (SHOWN ON PLAN AND PROFILE) ARE TAKEN ALONG THE CENTERLINE UNLESS OTHERWISE NOTED ON PLAN, AND SHOW MEASUREMENTS IN A HORIZONTAL PLANE.
- 18) FADED BACKGROUND REPRESENTS EXISTING TOPOGRAPHICAL FEATURES.
- 19) WORK DONE WITHIN THE COUNTY OF NAPA RIGHT-OF-WAY SHALL BE DONE UNDER AN ENCROACHMENT PERMIT ISSUED BY THE COUNTY OF NAPA.
- 20) STORM DRAIN PIPE IN THE COUNTY OF NAPA RIGHT-OF-WAY ARE AS FOLLOWS SHALL MEET THE FOLLOWING REQUIREMENTS:

 A) CAST-IN-PLACE PIPE SHALL BE USED ONLY OUTSIDE OF ROADWAY IN CONFORMANCE WITH CALTRANS STANDARD SPECIFICATIONS.

 B) REINFORCED CONCRETE PIPE CLASS III PER CALTRANS STANDARD SPECIFICATIONS.

 C) CORRUGATED POLYETHYLENE PIPE POLYETHYLENE NOT TO BE USED IN SIZES LARGER THAN 36".

COUNTY OF NAPA STORMWATER CONTROL NOTES

1) SEE STORM WATER CONTROL PLAN TEMPLATE PROJECT DATA FORM DATED OCTOBER 31, 2018 FOR PROJECT INFORMATION AND RUNOFF REDUCTION
MEASURE(S) SELECTED.

COUNTY OF NAPA FIRE PROTECTION NOTES

1) SEE CAL FIRE PLAN FOR PROJECT FIRE PROTECTION NOTES, DETAILS AND INFORMATION.

COUNTY OF NAPA EROSION & SEDIMENT CONTROL NOTES

THE FOLLOWING NOTES REPRESENT MINIMUM ENFORCEMENT NOTES:

- 1) ALL MOVEMENT OF EARTH SHALL COMPLY WITH THE SPECIFICATION CONTAINED IN THE NAPA COUNTY GRADING ORDINANCE AND THE EROSION CONTROL PLAN OR SWPPP.
- 2) CONTRACTOR SHALL ELIMINATE OR MINIMIZE NON—STORM WATER DISCHARGES FROM THE CONSTRUCTION SITE TO STORM DRAINS AND OTHER WATER BODIES. ALL CONSTRUCTION ACTIVITIES SHALL BE PERFORMED IN A MANNER THAT MINIMIZES TO THE MAXIMUM EXTENT PRACTICABLE, ANY POLLUTANTS ENTERING DIRECTLY OR INDIRECTLY THE STORM WATER SYSTEM OR GROUND WATER. THE CONTRACTOR SHALL ENSURE THAT NO CONSTRUCTION MATERIALS (E.G. CLEANING FRESH CONCRETE FROM EQUIPMENT) ARE CONVEYED INTO THE STORM DRAIN SYSTEM. ALL MATERIALS THAT COULD CAUSE WATER POLLUTION (I.E. MOTOR OIL, FUELS, PAINTS, ETC.) SHALL BE STORED AND USED IN A MANNER THAT WILL NOT CAUSE ANY POLLUTION. ALL DISCARDED MATERIAL AND ANY ACCIDENTAL SPILLS SHALL BE REMOVED AND DISPOSED OF AT AN APPROVED DISPOSAL SITE. CONTRACTOR SHALL PROVIDE TO THE PUBLIC WORKS DEPARTMENT ANY CHANGES PROPOSED FROM THE PROJECT'S EROSION CONTROL PLAN AND SHALL PROVIDE A SCHEDULE FOR IMPLEMENTATION OF CONTROL MEASURES. CONTRACTOR SHALL MEET WITH COUNTY OF NAPA PUBLIC WORKS STAFF PRIOR TO OCTOBER 1 TO REVIEW STATUS OF PROJECT'S EROSION CONTROL AND WATER POLLUTION MEASURES. CONTRACTOR SHALL MEET THE REQUIREMENTS OF DISCHARGING TO A PUBLIC STORM DRAINAGE SYSTEM AS REQUIRED TO ENSURE COMPLIANCE BY THE COUNTY OF NAPA WITH ALL STATE AND FEDERAL LAWS AND REGULATIONS RELATED TO STORM WATER AS STIPULATED IN THE CLEAN WATER ACT. CONTRACTOR SHALL MEET THE REQUIREMENTS OF THE NATIONAL POLLUTANT DISCHARGE ELIMINATION SYSTEM (NPDES) PERMIT IN THE EFFECT PRIOR TO COMPLETION OF PROJECT CONSTRUCTION FOR STORM WATER DISCHARGES FROM THE MUNICIPAL STORM WATER SYSTEM OPERATED BY THE COUNTY OF NAPA. CONTRACTOR SHALL COMPLY WITH THE EROSION AND SEDIMENT CONTROL PLAN (ESCP) SUBMITTED BY DEVELOPER AS PART OF ITS APPLICATION AS (MODIFIED AND) APPROVED BY THE DIRECTOR OF PUBLIC WORKS.
- 3) CHANGES TO THIS EROSION AND SEDIMENT CONTROL PLAN TO MEET FIELD CONDITIONS SHALL BE MADE ONLY WITH THE APPROVAL OF/OR AT THE DIRECTION OF THE ENGINEER.
- 4) THE CONTRACTOR SHALL INFORM ALL CONSTRUCTION SITE WORKERS ABOUT THE MAJOR PROVISION OF THE EROSION AND SEDIMENT CONTROL PLAN AND SEEK THEIR COOPERATION IN AVOIDING THE DISTURBANCE OF THESE EROSION CONTROL MEASURES.
- 5) CONTRACTOR SHALL NOTIFY PLANNING, BUILDING, AND ENVIRONMENTAL SERVICES DEPARTMENT 48 HOURS PRIOR TO THE COMMENCEMENT OF CONSTRUCTION. FAILURE TO DO SO CONSTITUTES A VIOLATION OF THE APPROVED EROSION AND SEDIMENT CONTROL PLAN OR SWPPP.
- 6) REVIEW AND OR APPROVAL OF THE EROSION AND SEDIMENT CONTROL PLAN OR SWPPP SHALL NOT RELIEVE THE CONTRACTOR FROM HIS OR HER RESPONSIBILITIES FOR COMPLIANCE WITH THE REQUIREMENTS OF THE CONSTRUCTION SITE RUNOFF CONTROL MANUAL, NOR SHALL IT RELIEVE THE CONTRACTOR FROM ERRORS OR OMISSIONS IN THE APPROVED PLAN.
- 7) IF THE APPROVED PLAN NEEDS TO BE MODIFIED, ADDITIONAL EROSION, SEDIMENT, AND STORMWATER CONTROL MEASURES MAY BE REQUIRED AS DEEMED NECESSARY BY THE PLANNING, BUILDING, AND ENVIRONMENTAL SERVICES DEPARTMENT AND THE ENGINEER.
- 8) CONTRACTOR SHALL PROVIDE THE COUNTY OF NAPA PLANNING, BUILDING, AND ENVIRONMENTAL SERVICES DEPARTMENT, AN EROSION AND SEDIMENT CONTROL PLAN, AND A SCHEDULE FOR IMPLEMENTATION OF SUCH MEASURES FOR YEAR ROUND CONSTRUCTION ACTIVITIES. HYDROSEEDING OF ALL GRADED SLOPES SHALL BE COMPLETED BY NOVEMBER 1ST.
- 9) THE DEVELOPER IS RESPONSIBLE TO ENFORCE THE BEST MANAGEMENT PRACTICES AT THE SITE ALONG WITH OTHER SOURCES.
- 10) EVERY EFFORT SHOULD BE MADE TO ELIMINATE THE DISCHARGE OF NON-STORMWATER FROM THE PROJECT SITE AT ALL TIMES.
- 11) ERODED SEDIMENTS AND OTHER POLLUTANTS MUST BE RETAINED ON SITE AND MAY NOT BE TRANSPORTED FROM THE SITE VIA SHEET-FLOW, SWALES, AREA DRAINS, NATURAL DRAINAGE COURSES, OR WIND.
- 12) STOCKPILES OF EARTH AND OTHER CONSTRUCTION—RELATED MATERIALS MUST BE PROTECTED FROM BEING TRANSPORTED FROM THE SITE BY THE FORCES OF WIND OR WATER.
- 13) FUELS, OILS, SOLVENTS, AND OTHER TOXIC MATERIALS MUST BE STORED IN ACCORDANCE WITH THEIR LISTING AND ARE NOT TO CONTAMINATE THE SOIL AND SURFACE WATERS. ALL APPROVED STORAGE CONTAINERS ARE TO BE PROTECTED FROM THE WEATHER. SPILLS MUST BE CLEANED UP IMMEDIATELY AND DISPOSED OF IN A PROPER MANNER. SPILLS MAY NOT BE WASHED INTO THE DRAINAGE SYSTEM.
- 14) EXCESS OR WASTE CONCRETE MAY NOT BE WASHED INTO THE PUBLIC RIGHT-OF-WAY OR ANY OTHER DRAINAGE SYSTEM. PROVISIONS SHALL BE MADE TO RETAIN CONCRETE WASTES ON SITE UNTIL THEY CAN BE DISPOSED OF AS SOLID WASTE.
- 15) TRASH AND CONSTRUCTION—RELATED SOLID WASTES MUST BE DEPOSITED INTO A COVERED RECEPTACLE TO PREVENT CONTAMINATION OF RAINWATER AND DISPERSAL BY WIND.
- 16) SEDIMENTS AND OTHER MATERIALS MAY NOT BE TRACKED FROM THE SITE BY VEHICLE TRAFFIC. THE CONSTRUCTION ENTRANCE ROADWAYS MUST
 BE STABILIZED SO AS TO INHIBIT SEDIMENTS FROM BEING DEPOSITED INTO THE PUBLIC RIGHT—OF—WAY. ACCIDENTAL DEPOSITIONS MUST BE SWEPT UP
 IMMEDIATELY AND MAY NOT BE WASHED DOWN BY RAIN OR OTHER MEANS.
- 17) ANY SLOPES WITH DISTURBED SOILS OR DENUDED OF VEGETATION MUST BE STABILIZED SO AS TO INHIBIT EROSION BY WIND AND WATER.
- 18) A STAND-BY CREW FOR EMERGENCY WORK SHALL BE AVAILABLE AT ALL TIMES. NECESSARY MATERIALS SHALL BE AVAILABLE ON-SITE AND STOCKPILED AT CONVENIENT LOCATIONS TO FACILITATE RAPID CONSTRUCTION OF EMERGENCY DEVICES WHEN RAIN IS IMMINENT.
- 19) EROSION CONTROL DEVICES SHOWN ON THIS PLAN MAY BE REMOVED WHEN APPPROVED BY THE BUILDING OFFICIAL IF THE GRADING OPERATION HAS PROGRESSED TO THE POINT WHERE THEY ARE NO LONGER REQUIRED.
- 20) GRADED AREAS ADJACENT TO FILL SLOPES LOCATED AT THE SITE PERIMETER MUST DRAIN AWAY FROM THE TOP OF SLOPE AT THE CONCLUSION
 OF EACH WORKING DAY. ALL LOOSE SOILS AND DEBRIS THAT MAY CREATE A POTENTIAL HAZARD TO OFF—SITE PROPERTY SHALL BE STABILIZED OR
 REMOVED FROM THE SITE ON A DAILY BASIS.
- 21) ALL SILT AND DEBRIS SHALL BE REMOVED FROM ALL DEVICES WITHIN 24 HOURS AFTER EACH RAINSTORM AND BE DISPOSED OF PROPERLY.
- 22) A GUARD SHALL BE POSTED ON THE SITE WHENEVER THE DEPTH OF WATER IN ANY DEVICES EXCEEDS TWO FEET. THE DEVICE SHALL BE

 DRAINED OR PUMPED WITHIN 24 HOURS AFTER EACH RAINSTORM. PUMPING AND DRAINING OF ALL BASINS AND DRAINAGE DEVICES MUST COMPLY
 WITH THE APPROPRIATE BMP FOR DEWATERING OPERATIONS.

COUNTY OF NAPA EROSION & SEDIMENT CONTROL NOTES CONTINUED..

- 23) THE PLACEMENT OF ADDITIONAL DEVICES TO REDUCE EROSION DAMAGE AND CONTAIN POLLUTANTS WITHIN THE SITE IS LEFT TO THE DISCRETION OF THE FIELD ENGINEER. ADDITIONAL DEVICES AS NEEDED SHALL BE INSTALLED TO RETAIN SEDIMENTS AND OTHER POLLUTANTS ON SITE.
- 24) DESTILING BASINS MAY NOT BE REMOVED OR MADE INOPERABLE BETWEEN NOVEMBER 1 AND APRIL 15 OF THE FOLLOWING YEAR WITHOUT THE APPROVAL OF THE BUILDING OFFICIAL.
- 25) STORMWATER POLLUTION AND EROSION CONTROL DEVICES ARE TO BE MODIFIED, AS NEEDED, AS THE PROJECT PROGRESSES, THE DESIGN AND
 PLACEMENT OF THESE DEVICES IS THE RESPONSIBILITY OF THE FIELD ENGINEER. PLANS REPRESENTING CHANGES MUST BE SUBMITTED FOR APPROVAL
 IF REQUESTED BY THE BUILDING OFFICIAL.
- 26) DEVELOPERS/CONTRACTORS, ARE RESPONSIBLE TO INSPECT ALL EROSION CONTROL DEVICES AND BMPs ARE INSTALLED AND FUNCTIONING
 PROPERLY, IF THERE IS A 50% CHANCE OF 0.25 INCHES OR GREATER OF PREDICTED PRECIPITATION, AND AFTER ACTUAL PRECIPITATION. A
 CONSTRUCTION SITE INSPECTION CHECKLIST AND INSPECTION LOG SHALL BE MAINTAINED AT THE PROJECT SITE AT ALL TIMES AND AVAILABLE FOR REVIEW BY THE BUILDING OFFICIAL (SELF—INSPECTION CHECK LIST).
- 27) TRASH AND CONSTRUCTION—RELATED SOLID WASTES MUST BE DEPOSITED INTO A COVERED RECEPTACLE TO PREVENT CONTAMINATION OF RAINWATER AND DISPERSAL BY WIND.

COUNTY OF NAPA GRADING NOTES CONTINUED


- 1) ALL GRADING SHALL BE DONE IN ACCORDANCE WITH THE RECOMMENDATIONS IN THE LATEST EDITION OF THE CALIFORNIA BUILDING CODE AND THE GEOTECHNICAL REPORT. CONTRACTOR IS TO CONTACT THE ENGINEER IF ANY DISCREPANCIES ARISE BEFORE COMMENCING WORK.
- 2) GRADING ON THE SITE SHALL BE LIMITED TO THE AREA SHOWN ON THE PLAN.
- 3) THE GEOTECHNICAL ENGINEER SHALL BE NOTIFIED AT LEAST THREE (3) DAYS IN ADVANCE OF COMMENCING WORK, INCLUDING SITE STRIPPING AND GRADING OPERATIONS. THIS WORK SHALL BE OBSERVED AND TESTED BY THE GEOTECHNICAL ENGINEER'S REPRESENTATIVE.
- 4) SITE SHALL BE VISUALLY INSPECTED BY THE CONTRACTOR TO DETERMINE THE EXTENT OF CLEARING, GRUBBING, AND GRADING WORK TO BE PERFORMED.
- 5) EXCESS SOIL SHALL BE STOCKPILED AT A LOCATION SPECIFIED BY THE PERMITS.
- 6) TREES THAT ARE REMOVED SHALL ALSO HAVE THEIR STUMPS AND MAJOR ROOT SYSTEMS REMOVED. AFTER A TREE OR A STUMP IS REMOVED THE RESULTING EARTH CAVITY SHALL BE CLEANED OF LARER ROOTS (2—INCH DIAMETER AND LARGER). SOILS SHOULD BE REMOVED TO PROVIDE ACCESS FOR COMPACTION EQUIPMENT. ALL EARTHWORK, SCARIFICATION, BACKFILL, AND COMPACTION SHALL BE PERFORMED PER THE GEOTECHNICAL REPORT AND GEOTECHNICAL ENGINEER'S REQUIREMENTS.
- 7) THE CONTRACTOR SHALL BE RESPONSIBLE TO CALL UNDERGROUND SERVICE ALERT (USA) AT LEAST TWO WORKING DAYS PRIOR TO DIGGING HOLES, TRENCHES, ETC. DIAL 811 OR 1-800-227-2600.
- 8) CONTRACTOR SHALL CONDUCT ALL GRADING OPERATIONS IN SUCH A MANNER AS TO PRECLUDE WIND BLOWN DIRT AND DUST AND RELATED

 DAMAGE TO NEIGHBORING PROPERTIES. SUFFICIENT WATERING TO CONTROL DUST IS REQUIRED AT ALL TIMES. CONTRACTOR SHALL ASSUME LIABILITY

 FOR CLAIMS RELATED TO WIND BLOWN MATERIAL. IF THE DUST CONTROL IN INADEQUATE AS DETERMINED BY THE PUBLIC WORKS DIRECTOR OR HIS

 DESIGNATED REPRESENTATIVE, THE CONSTRUCTION WORK SHALL BE TERMINATED UNTIL CORRECTIVE MEASURES ARE TAKEN.
- 9) ANY EARTH MATERIAL IMPORTED OR EXCAVATED ON THE PROPERTY MAY BE UTILIZED IN THE FILL PROVIDED THAT EACH MATERIAL HAS BEEN DETERMINED TO BE SUITABLE BY THE GEOTECHNICAL ENGINEER. ALL FILL SHALL BE FREE OF ORGANIC AND OTHER DELETERIOUS MATERIAL. SOILS OF POOR GRADATION, EXPANSION POTENTIAL, OR STRENGTH CHARACTERISTICS SHALL BE PLACED IN AREAS DESIGNATED BY THE CONSULTANT OR SHALL BE MIXED WITH OTHER SOILS TO THE SATISFACTION OF THE SOILS ENGINEER.
- 10) FINISHED GRADES IN ALL AREAS SHALL COMPLY WITH PLAN ELEVATIONS. NO AREAS SHALL BE LEFT SUCH THAT A PONDING CONDITION OCCURS.
- 11) OVER EXCAVATION, FILL, COMPACTION, AND FOOTING DEPTH SHALL CONFORM TO THE GEOTECHNICAL ENGINEERS SOILS REPORT.
- 12) CUT AND FILL SLOPES WILL NOT EXCEED A STEEPNESS OF 2:1, UNLESS OTHERWISE NOTED.
- 13) ALL CONSTRUCTION SHALL ADHERE TO THE CONDITIONS SET FORTH IN THE USE PERMIT, GRADING PERMIT, AND ENCROACHMENT PERMIT ON FILE WITH THE COUNTY OF NAPA.
- 14) CONTRACTOR AGREES THAT IN ACCORDANCE WITH GENERALLY ACCEPTED CONSTRUCTION PRACTICES, CONTRACTOR WILL BE REQUIRED TO ASSUME SOLE AND COMPLETE RESPONSIBILITY FOR JOB SITE CONDITIONS DURING THE COURSE OF CONSTRUCTION OF THE PROJECT, INCLUDING SAFETY OF ALL PERSONS AND PROPERTY; THAT THIS REQUIREMENT SHALL BE MADE TO APPLY CONTINUOUSLY AND NOT BE LIMITED TO NORMAL WORKING HOURS, AND CONSTRUCTION CONTRACTOR FURTHER AGREES TO DEFEND, INDEMNIFY AND HOLD DESIGN PROFESSIONAL HARMLESS FROM ANY AND ALL LIABILITY, REAL OR ALLEGED, IN CONNECTION WITH THE PERFORMANCE OF WORK ON THIS PROJECT.


NORTH BA

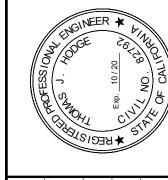

SCALE AS SHOWN
DESIGNED BY EVM
DRAWN BY AXA

ENERAL NOTI

C2.0

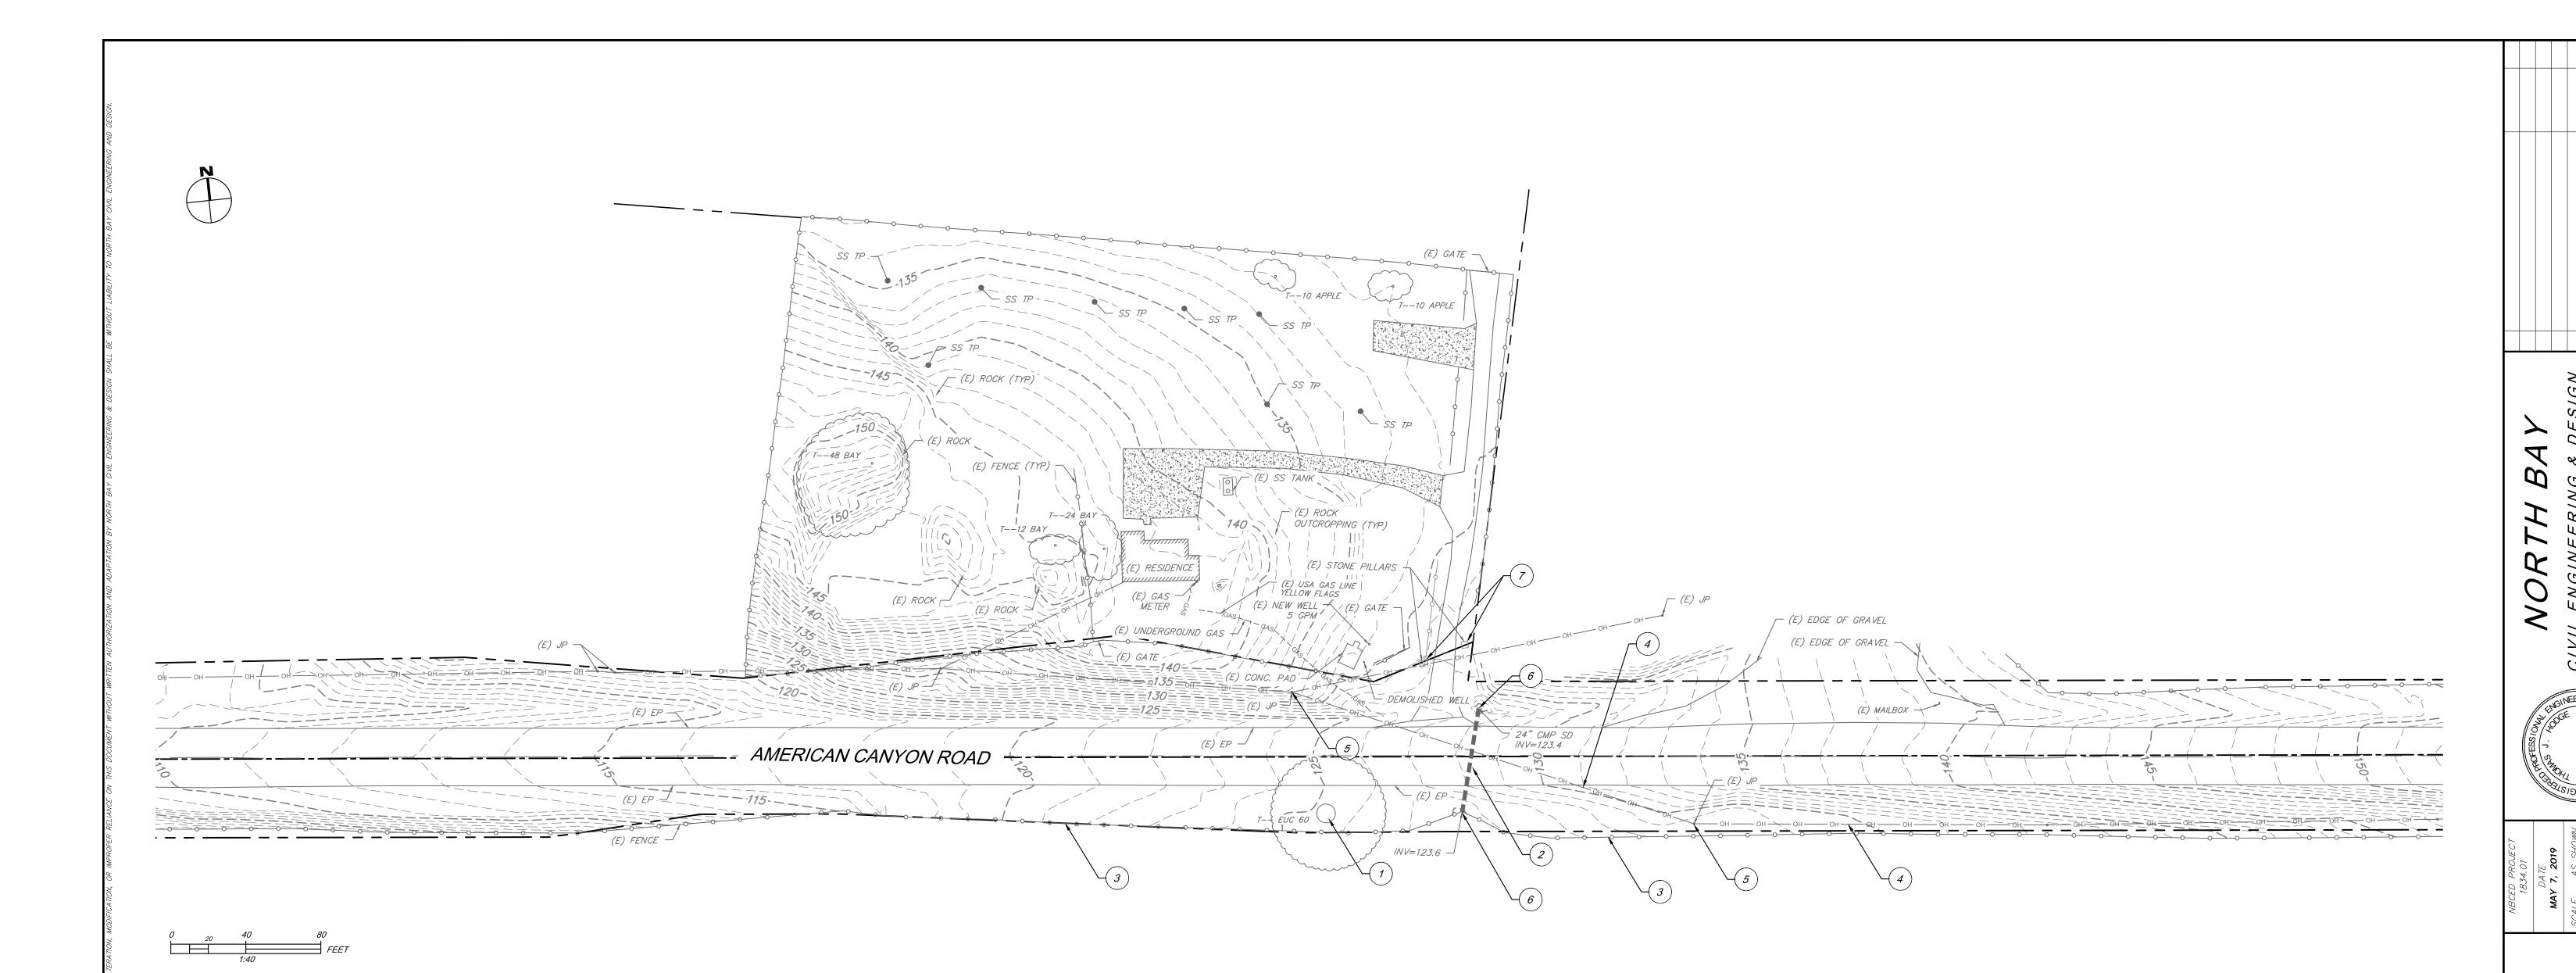

DEMOLITION CONSTRUCTION NOTES

REMOVE (E) 60" EUCALYPTUS TREE

PROTECT IN PLACE (E) CULVERT

PROTECT IN PLACE (E) FENCE

PROTECT IN PLACE (E) OVERHEAD ELECTRIC LINE

PROTECT IN PLACE (E) JOINT POLE

PROTECT IN PLACE (E) INLET/OUTLET


REMOVE (E) STONE PILLAR

DEMOLITION NOTES:

- 1) EXISTING STRUCTURES, IMPROVEMENTS, UTILITIES, AND FEATURES ARE SHOWN IN THEIR APPROXIMATE LOCATIONS BASED UPON RECORD INFORMATION AVAILABLE TO THE ENGINEER AT THE TIME OF THE PREPARATION OF THESE PLANS. LOCATIONS HAVE NOT BEEN VERIFIED IN THE FIELD AND NO GUARANTEE IS MADE TO THE ACCURACY OR COMPLETENESS OF THE INFORMATION SHOWN. CONTRACTOR AND ALL SUBCONTRACTORS SHALL VERIFY ALL INFORMATION PRIOR TO THE COMMENCEMENT OF CONSTRUTION.
- 2) ANY EXISTING IMPROVEMENTS, UTILITIES, OR FEATURES DAMAGED OR REMOVED DURING THE COURSE OF CONSTRUCTION SHALL BE REPLACED OR RESTORED IN KIND AT THE CONTRACTORS SOLE EXPENSE.
- 3) SURFACE RESTORATION OF ANY DAMAGED ROADWAY DURING CONSTRUCTION SHALL BE PERFORMED IN ACCORDANCE WITH THE LATEST COUNTY OF NAPA STANDARD DETAILS AND SPECIFICATIONS. ALL ROADWAY MARKINGS AND SIGNAGE TO BE RESTORED TO PRE-PROJECT CONDITIONS TO THE SATISFACTION OF THE ENGINEER AND THE COUNTY OF NAPA PUBLIC WORKS.
- 4) THE CONTRACTOR AND ALL SUBCONTRACTORS SHALL CALL UNDERGROUND SERVICE ALERT (USA NORTH 811 OR 1-800-227-2600) PRIOR TO THE COMMENCEMENT OF ANY WORK ON THE PROJECT SITE.



Know what's **below. Call** before you dig.

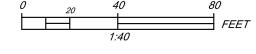

GRADING NOTES:

- 1) EXCAVATION AND GRADING SHALL COMPLY WITH THE LATEST EDITION OF THE UNIFORM BUILDING CODE

 AS WELL AS THE GEOTECHNICAL REPORT PREPARED BY JIM GLOMB AND

 DATED DECEMBER 16, 2015.
- 2) A GEOTECHNICAL REPORT FOR THIS PROJECT WAS PREPARED AND SHALL BECOME A PART OF THESE PLANS. SITE PREPARATION, EXCAVATION, GRADING, FILL PLACEMENT AND COMPACTION SHALL CONFORM WITH THE PROJECT GEOTECHNICAL REPORT AND WITH THE RECOMMENDATIONS OF THE GEOTECHNICAL ENGINEER. FILED OBSERVATION AND TESTING DURING THE GRADING OPERATIONS SHALL BE PROVIDED BY REPRESENTATIVE OF THE GEOTECHNICAL ENGINEER TO ENABLE THEM TO FORM AN OPINION REGARDING THE ADEQUACY OF THE SITE PREPARATION, THE ACCEPTABILITY OF FILL MATERIALS AND THE EXTENT TO WHICH THE EARTH CONSTRUCTION AND THE DEGREE OF COMPACTION COMPLY WITH THE SPECIFICATION REQUIREMENTS. NOTIFY THE GEOTECHNICAL ENGINEER AT LEAST TWO (2) WORKING DAYS PRIOR TO BEGINNING WORK.
- 3) CONTRACTOR SHALL CONDUCT ALL GRADING OPERATIONS IN SUCH A MANNER AS TO PRECLUDE WIND BLOWN DIRT AND DUST AND RELATED DAMAGE TO NEIGHBORING PROPERTIES. SUFFICIENT WATERING TO CONTROL DUST IS REQUIRED AT ALL TIMES. CONTRACTOR SHALL ASSUME LIABILITY FOR CLAIMS RELATED TO WIND BLOWN MATERIAL. IF THE DUST CONTROL IS INADEQUATE AS DETERMINED BY THE PUBLIC WORKS DIRECTOR OR HIS DESIGNATED REPRESENTATIVE, THE CONSTRUCTION WORK SHALL BE TERMINATED UNTIL CORRECTIVE MEASURES ARE TAKEN.
- 4) THE SITE SHOULD BE CLEARED OF ALL SURFACE AND SUBSURFACE DELETERIOUS MATERIALS INCLUDING EXISTING BUILDINGS AND ASSOCIATED FOUNDATIONS, SLABS, ABANDONED UTILITIES, IRRIGATION LINES, PAVEMENTS, DEBRIS, DESIGNATED TREES, SHRUBS, AND ASSOCIATED ROOT SYSTEMS. SUCH MATERIALS SHOULD BE REMOVED FROM SITE AND DISPOSED IN ACCORDANCE COUNTY OF NAPA GUIDELINES.
- 5) GRADE ALL PLANTER AND LANDSCAPE AREAS TO DRAIN AWAY FROM BUILDING.

GRADING NOTES:

- 6) PITS, CISTERNS, SEPTIC TANKS, LEACH LINES, UNDERGROUND FUEL TANKS AND ASSOCIATED

 APPURTENANCES FOUND DURING GRADING SHOULD BE CAPPED AND SEALED AND/OR EXCAVATED AND

 REMOVED FROM THE SITE IN ACCORDANCE WITH COUNTY OF NAPA ESTABLISHED GUIDELINES.
- 7) THE CONTRACTOR SHALL BE RESPONSIBLE TO CONFIRM THE GROUND ELEVATIONS AND OVERALL TOPOGRAPHY OF THE SITE PRIOR TO START OF CONSTRUCTION. EXISTING CONTOURS AND ELEVATIONS SHOWN ARE CONTOURS AND ELEVATIONS PRIOR TO ANY SITE DEMOLITION.
- 8) ALL GRADING OPERATIONS DURING CONSTRUCTION SHALL BE MONITORED AND TESTED BY THE GEOTECHNICAL ENGINEER, INCLUDING SITE PREPARATION, PLACEMENT OF ALL ENGINEERING FILL AND TRENCH BACKFILL, CONSTRUCTION OF SLAB SUBGRADE, PAVEMENT CONSTRUCTION, AND ALL FOUNDATION EXCAVATIONS.
- 9) ALL GRADES SHOWN ARE FINISHED GRADES, UNLESS OTHERWISE NOTED.
- 10) FINISHED GRADES IN ALL AREAS SHALL COMPLY WITH PLAN ELEVATIONS. NO AREAS SHALL BE LEFT SUCH THAT A PONDING CONDITION OCCURS.
- 11) CUT AND FILL SLOPES WILL NOT EXCEED A STEEPNESS OF 2:1, UNLESS OTHERWISE NOTED.
- 12) ALL CONSTRUCTION SHALL ADHERE TO THE CONDITIONS SET FORTH IN THE USE PERMIT, GRADING PERMIT, AND ENCROACHMENT PERMIT ON FILE WITH THE COUNTY OF NAPA.

EARTHWORK SUMMARY *						
	CUT (CY)	FILL (CY)				
RAW QUANTITY	232	405				
NET VOLUMETRIC DIFFERENCE CUT/FILL	174 ± CY NET FILL (IMPORT)					
TOTAL PROJECT AREA	53,084 SF (1.22 AC)					

52,840 SF (1.21 AC)

* SEE EARTHWORK SUMMARY NOTES (THIS SHEET)


TOTAL DISTURBED AREA

EARTHWORK SUMMARY NOTES:


- 1) ALL QUANTITIES SHOWN ON THIS PLAN ARE APPROXIMATE. CUT AND FILLS WERE CALCULATED BASED
 ON THE VOLUMETRIC DIFFERENCE IN FINISHED GRADE AND EXISTING GRADE SURFACES.
- 2) DUE TO THE INEXACT NATURE OF EARTHWORK ESTIMATING, THERE IS NO GUARANTEE OF THE SHOWN QUANTITIES.
- 3) THE CONTRACTOR IS RESPONSIBLE FOR DETERMINING THEIR OWN EARTHWORK QUANTITIES PRIOR TO THE START OF CONSTRUCTION
- 4) THE CONTRACTOR SHALL ARRANGE FOR DISPOSAL OF EXCESS MATERIAL OR ACQUISITION OF IMPORT MATERIAL AS REQUIRED TO COMPLETE THE GRADING AS SHOWN ON THE PLANS. NO ADDITIONAL COMPENSATION SHALL BE MADE FOR ANY EXPORT OR IMPORT REQUIREMENTS.
- 5) NET VOLUMETRIC DIFFERENCE BETWEEN THE CUT & FILL IS FOR CONCEPTUAL PURPOSES ONLY AND SHALL NOT BE USED FOR ESTIMATING PURPOSES.
- 6) BANK, LOOSE (SWELL), AND COMPACTION (SHRINKAGE) VOLUME FACTORS WERE NOT APPLIED TO THE EARTHWORK SUMMARY.
- 7) FF INDICATES THE FINISHED FLOOR OF THE PROPOSED STRUCTURE. TO DETERMINE THE PAD ELEVATIONS, SUBTRACT THE STRUCTURAL SECTION OF THE PROPOSED FLOOR FROM THE FINISHED FLOOR ELEVATIONS SHOWN. SEE PLANS BY OTHERS FOR MORE DETAILS.
- 8) FILL INCLUDES THE VOLUME OF THE STRUCTURAL SECTION OF THE PROPOSED STRUCTURAL SECTIONS. THIS INCLUDES, BUT IS NOT LIMITED TO, CONCRETE SLAB THICKNESS, BASE MATERIAL THICKNESS, ENGINEERED/SELECT FILL THICKNESS...ETC)
- 9) SOURCE OF FILL NOT YET DETERMINED. ALL FILL SHALL COME FROM A COUNTY OF NAPA APPROVED SITE WITH A PERMIT THAT ALLOWS THE OFF—HAUL OF IMPORT OF SPOILS.


Know what's below.
Call before you d


C4
s below.

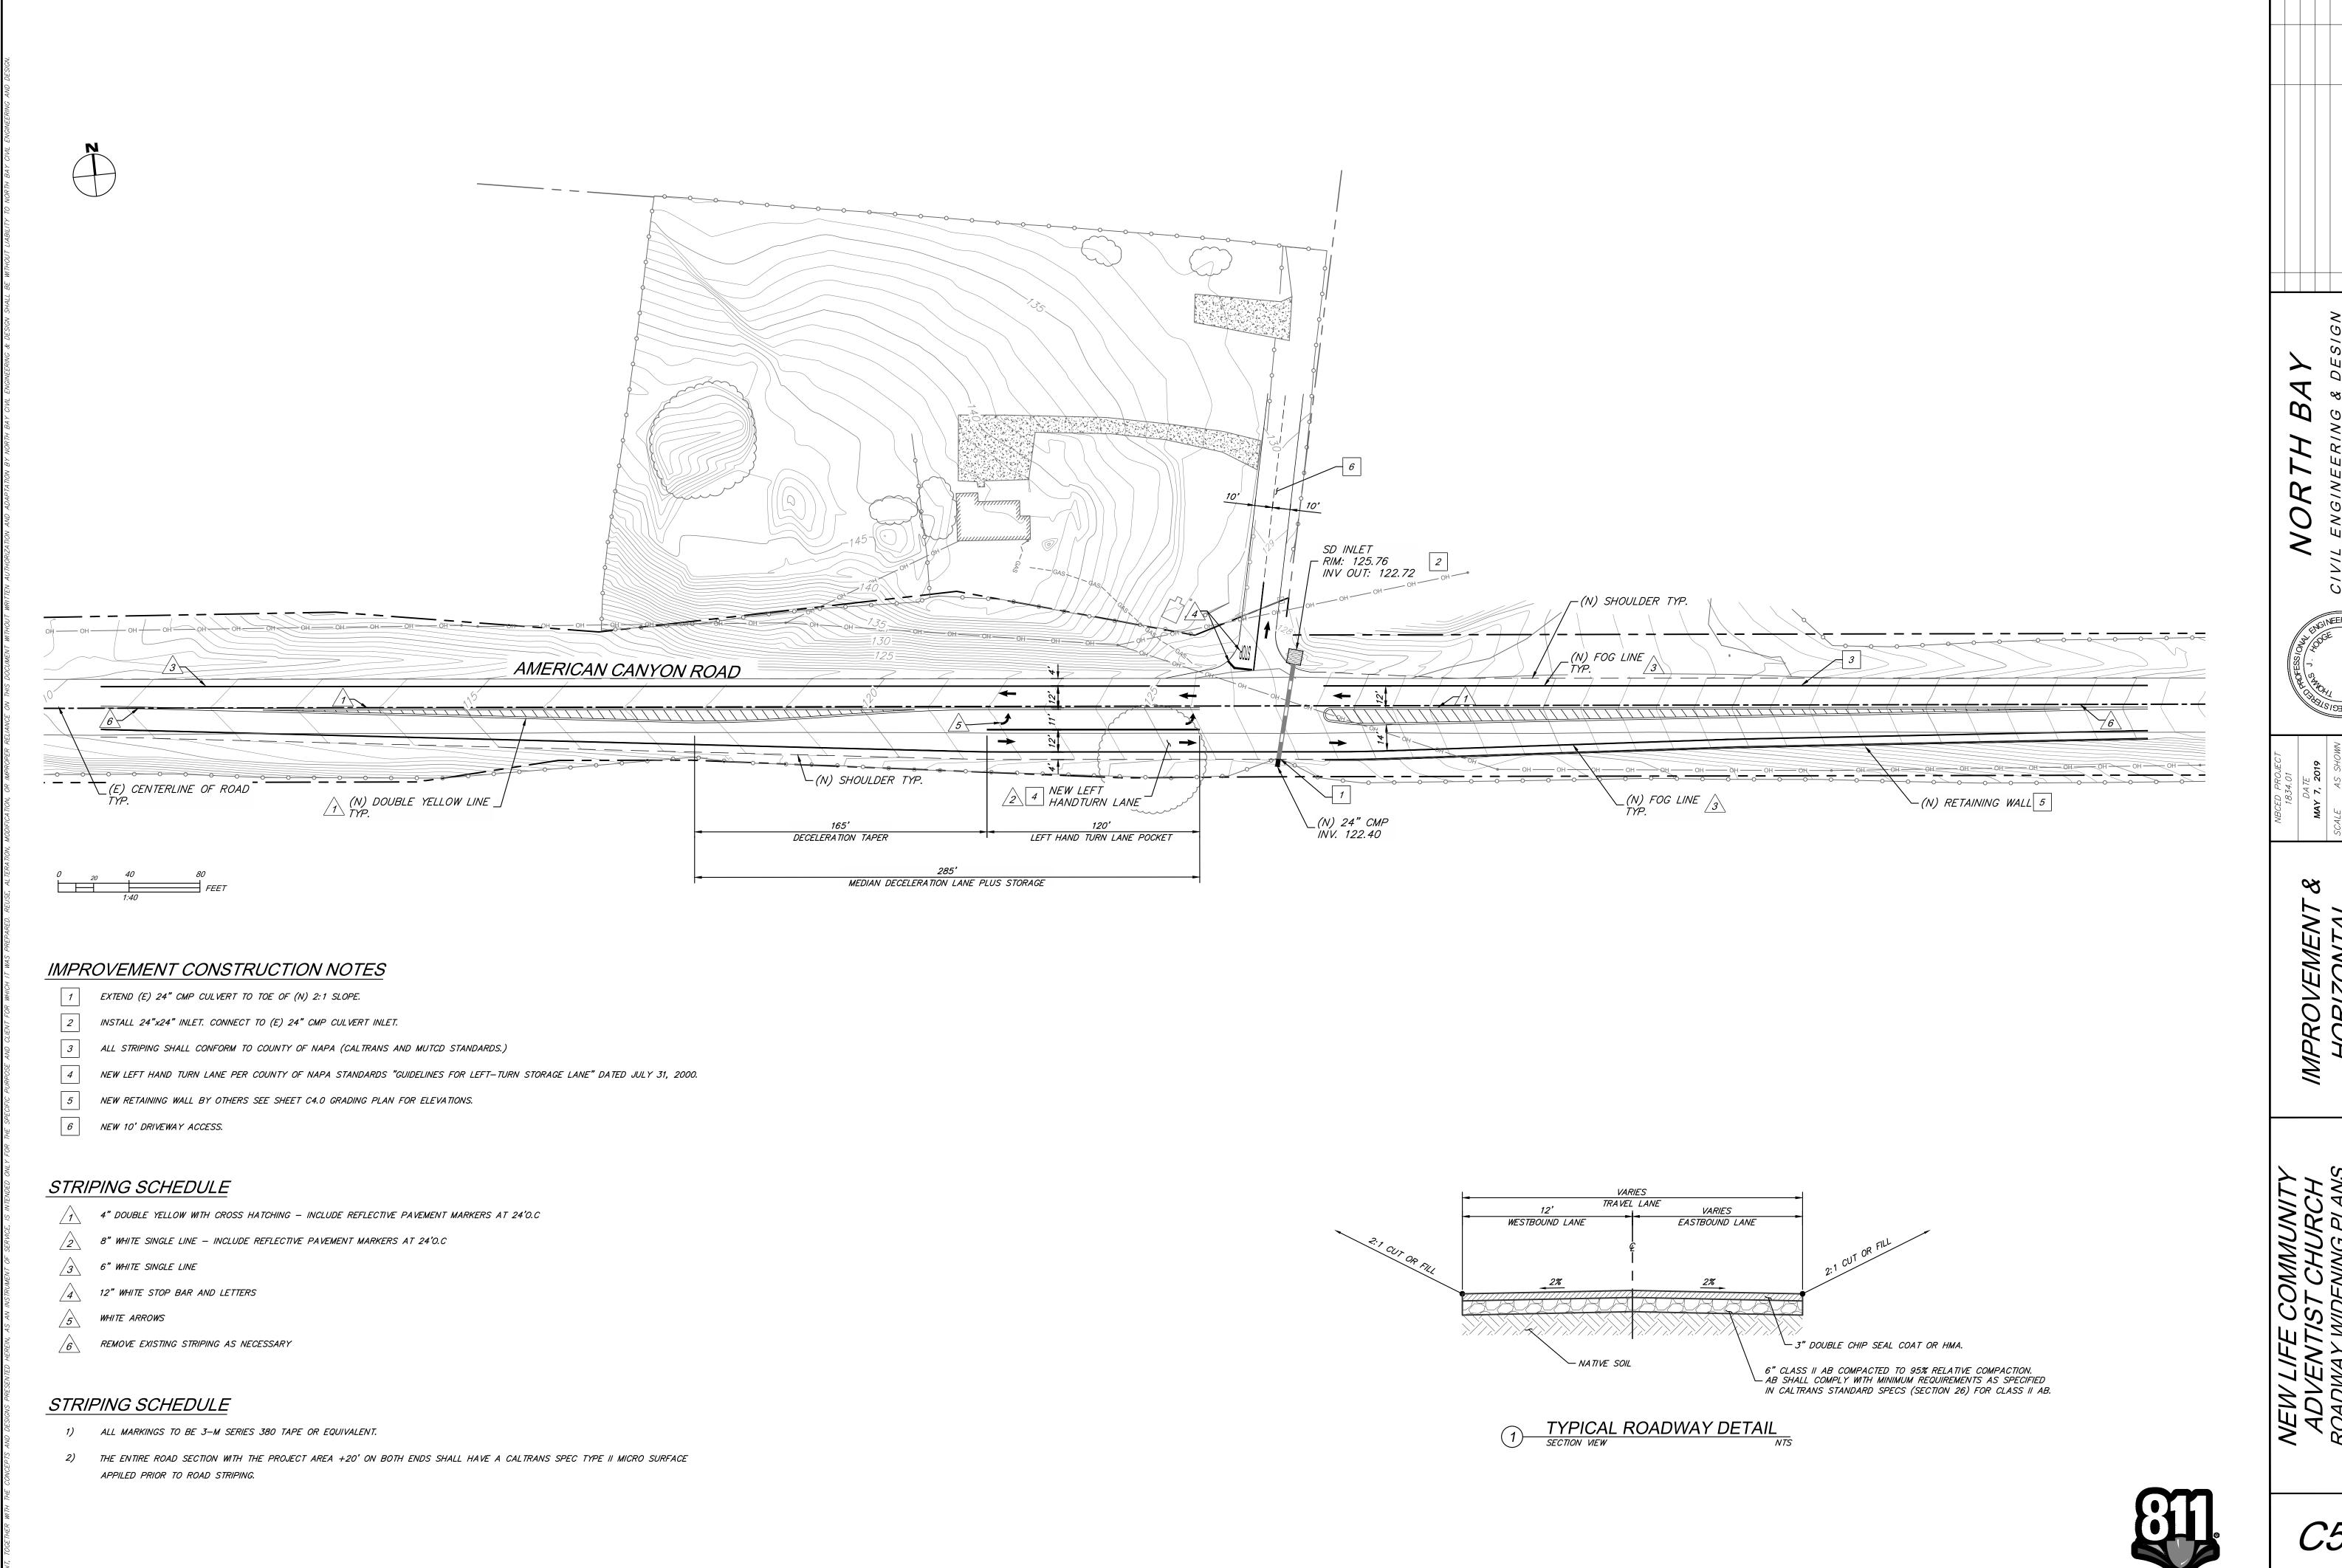


Know what's **below. Call** before you dig.

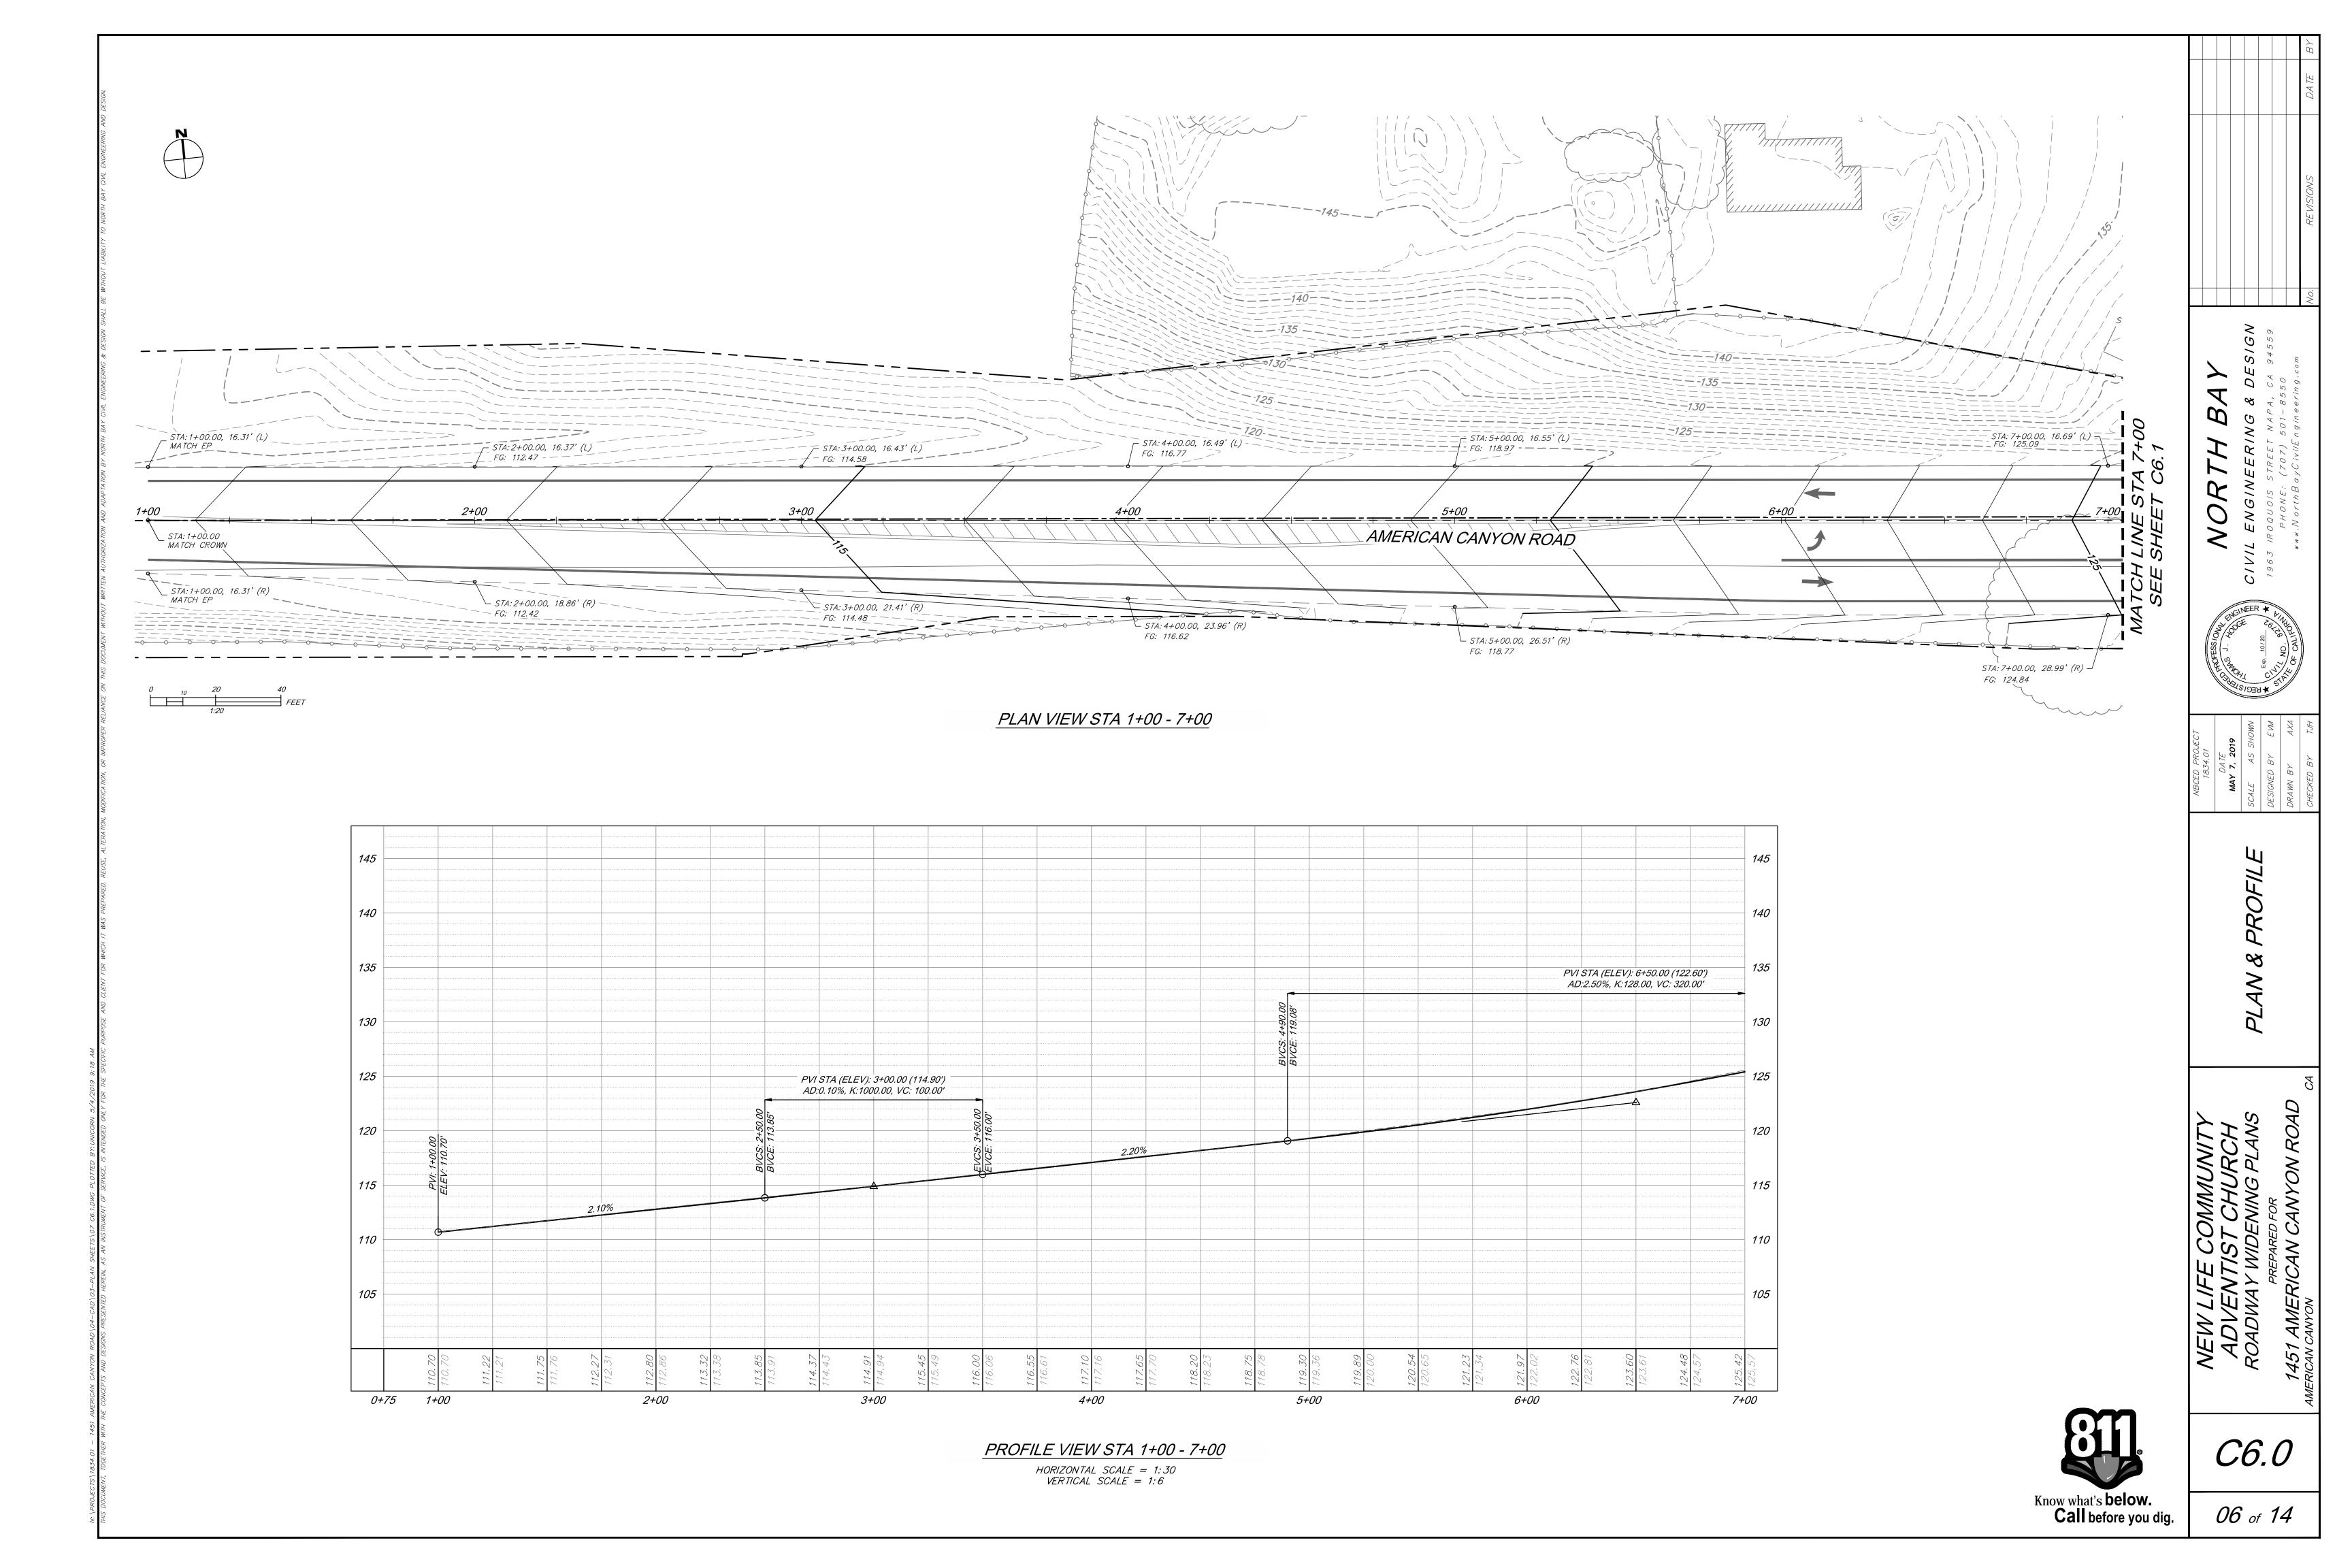

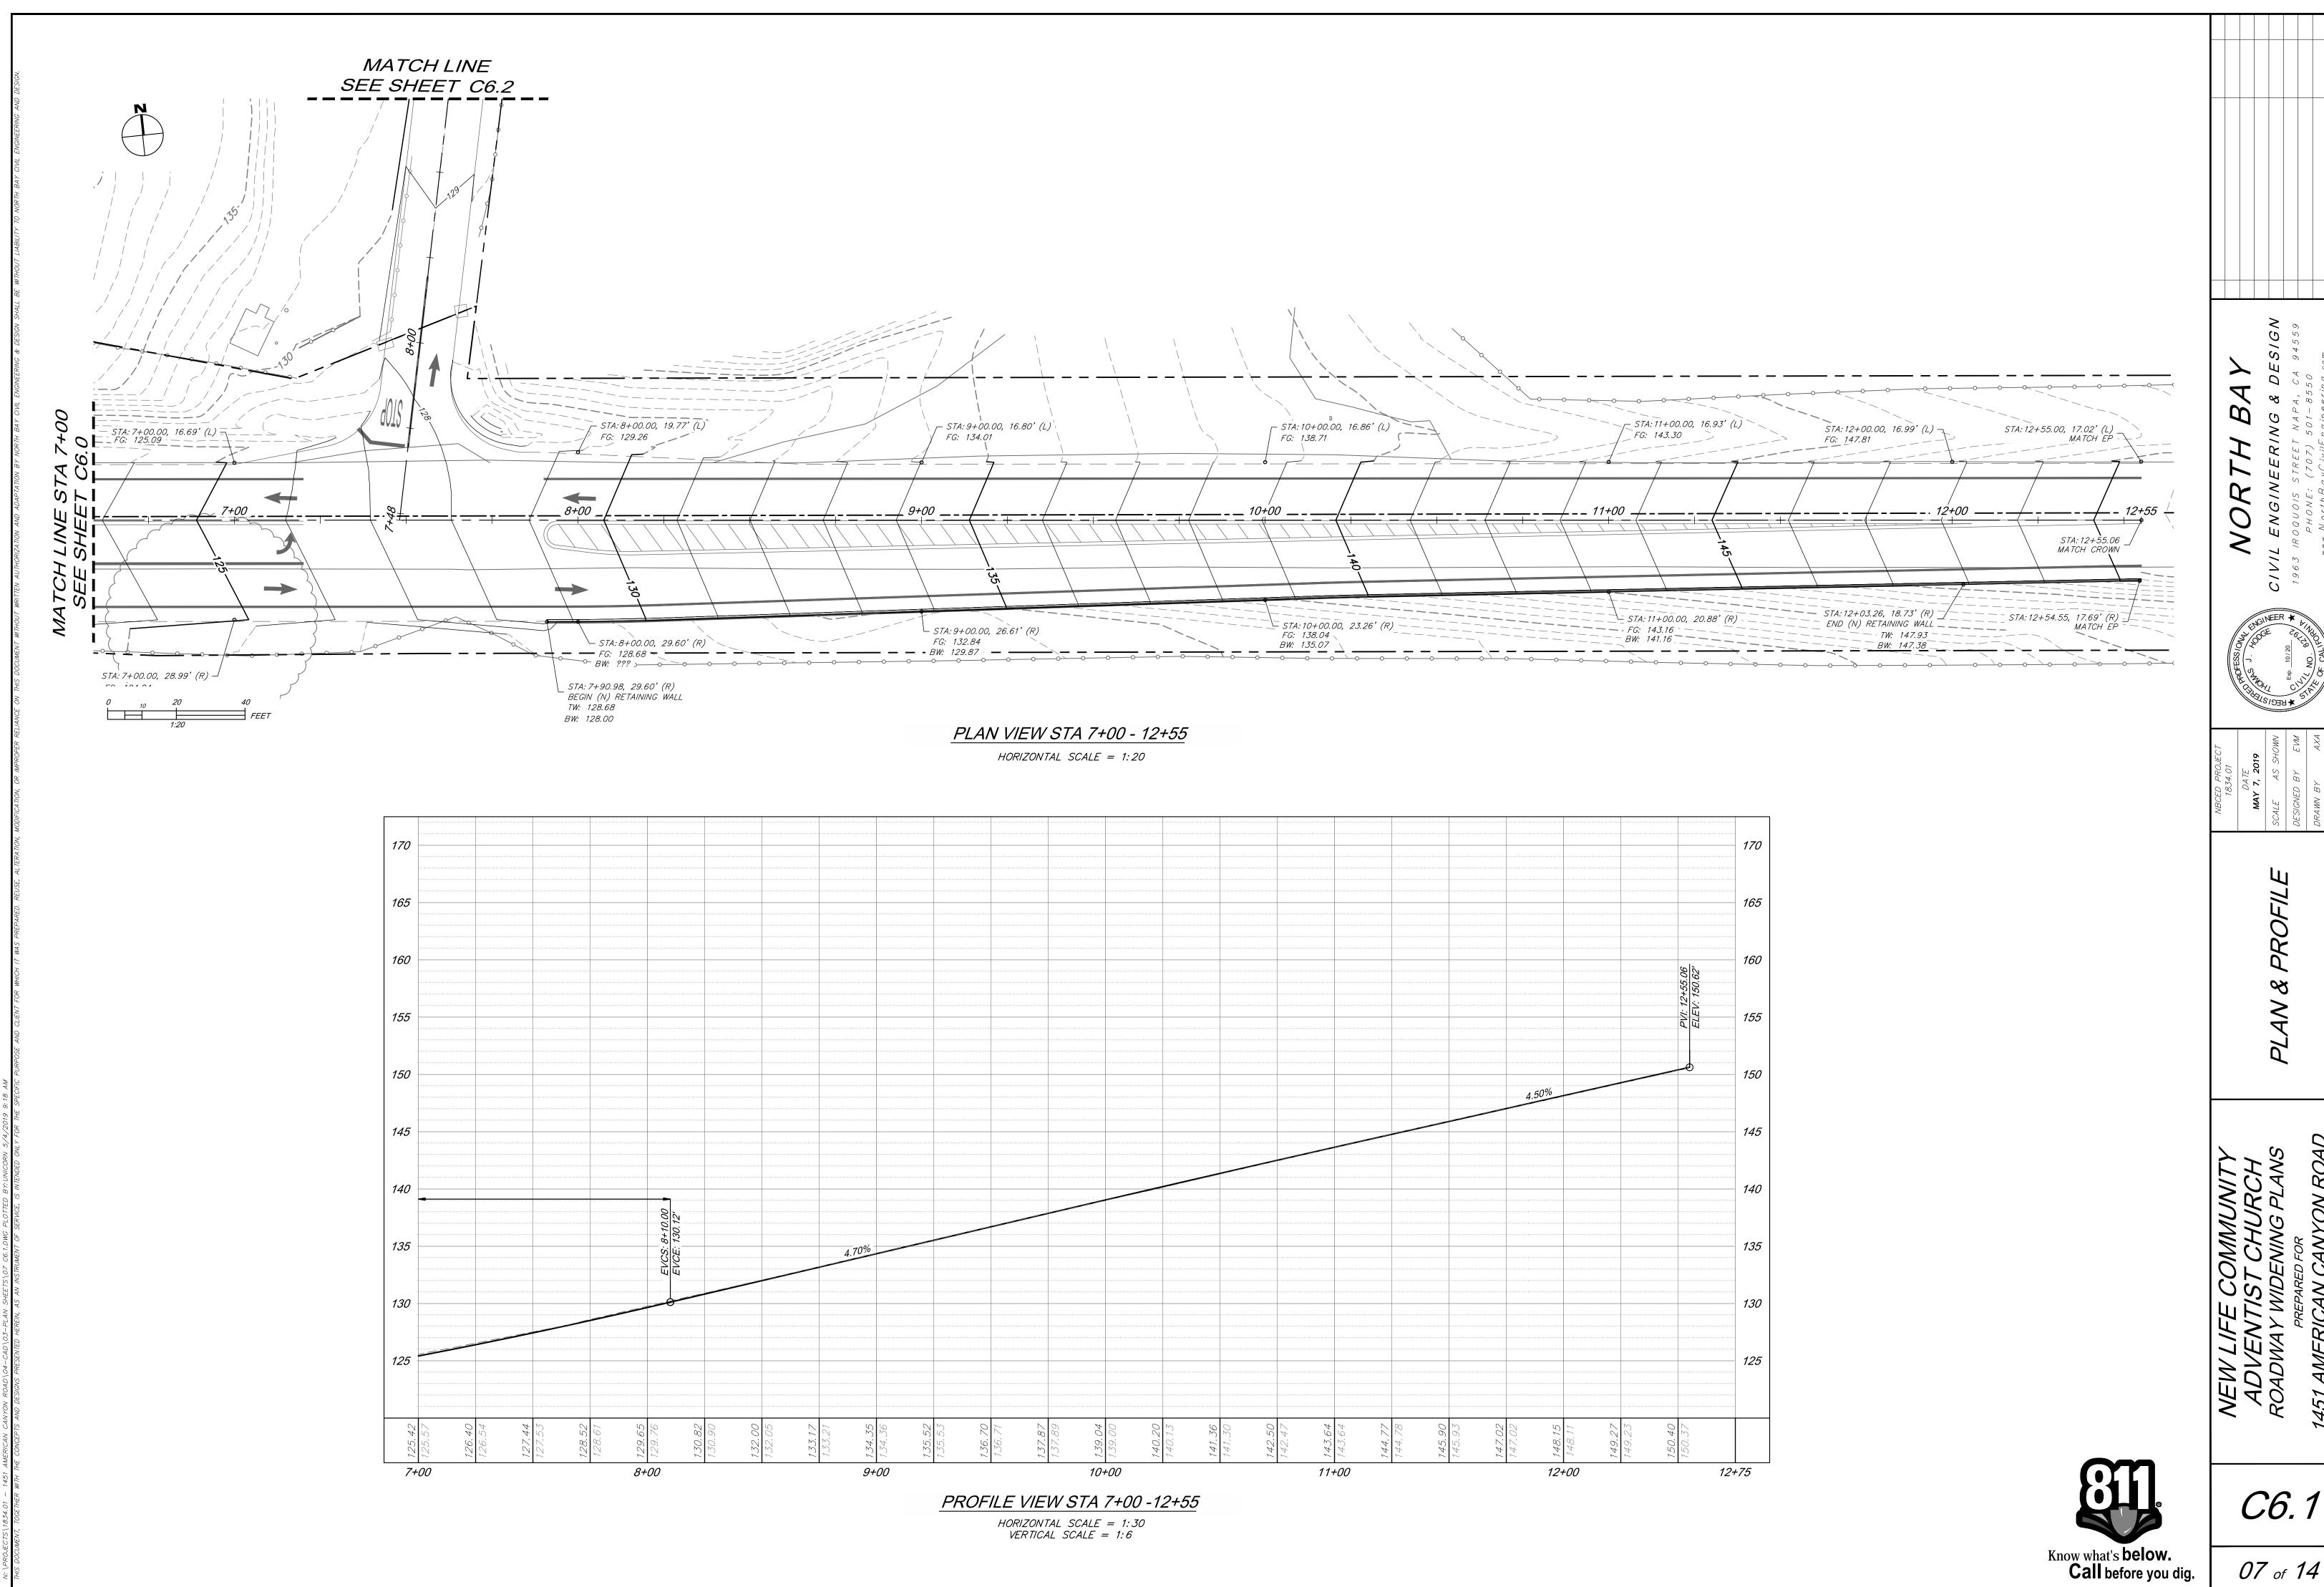

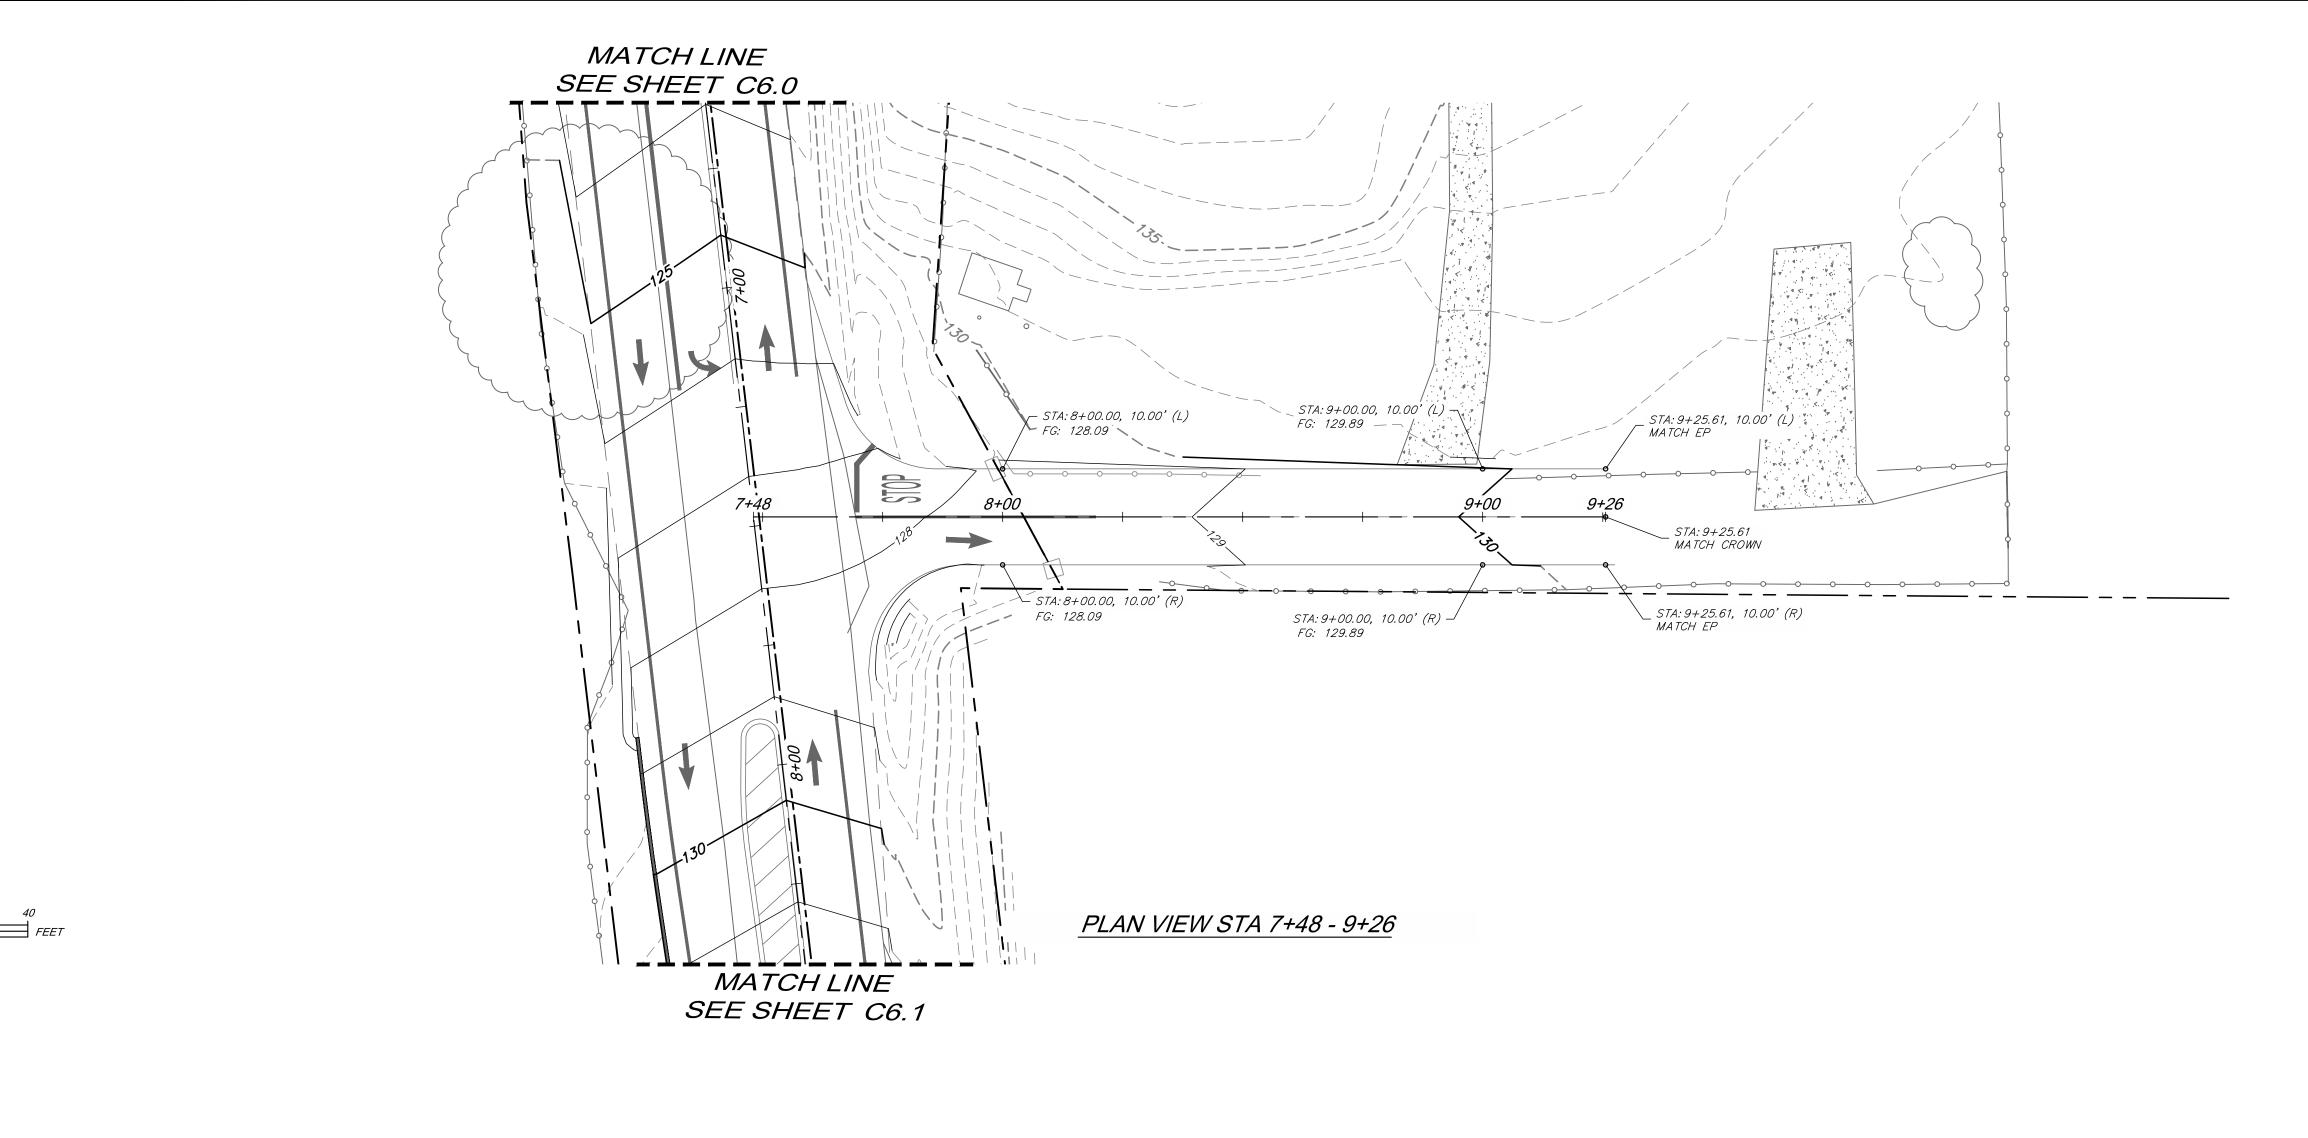

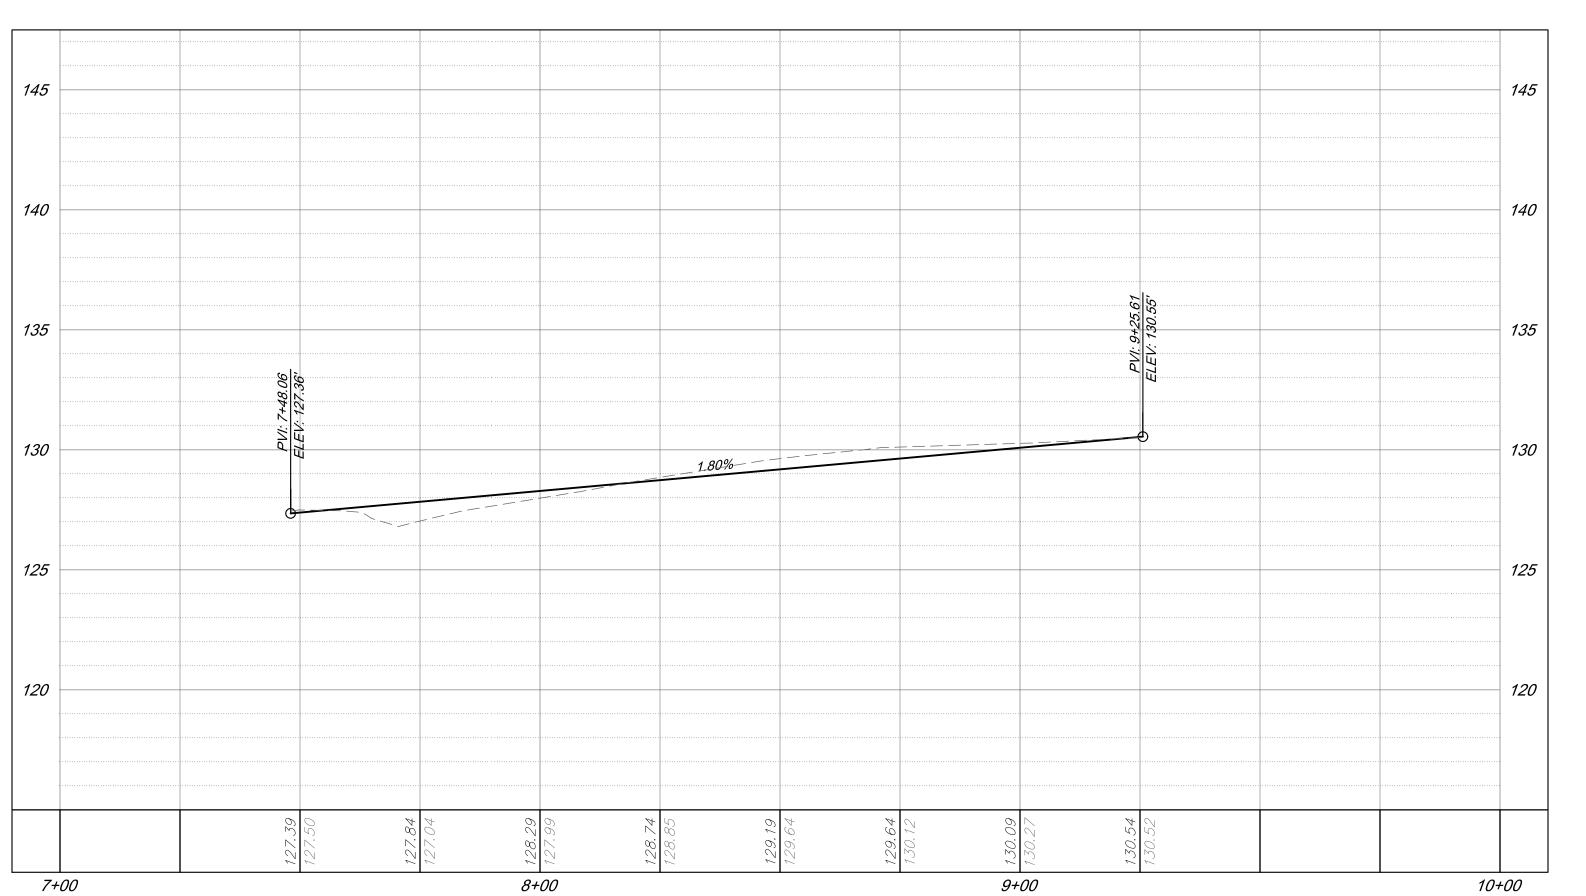


PROFILE VIEW STA 7+48 -9+26 HORIZONTAL SCALE = 1:30 VERTICAL SCALE = 1:6




C6.2

PLAN & PROFIL

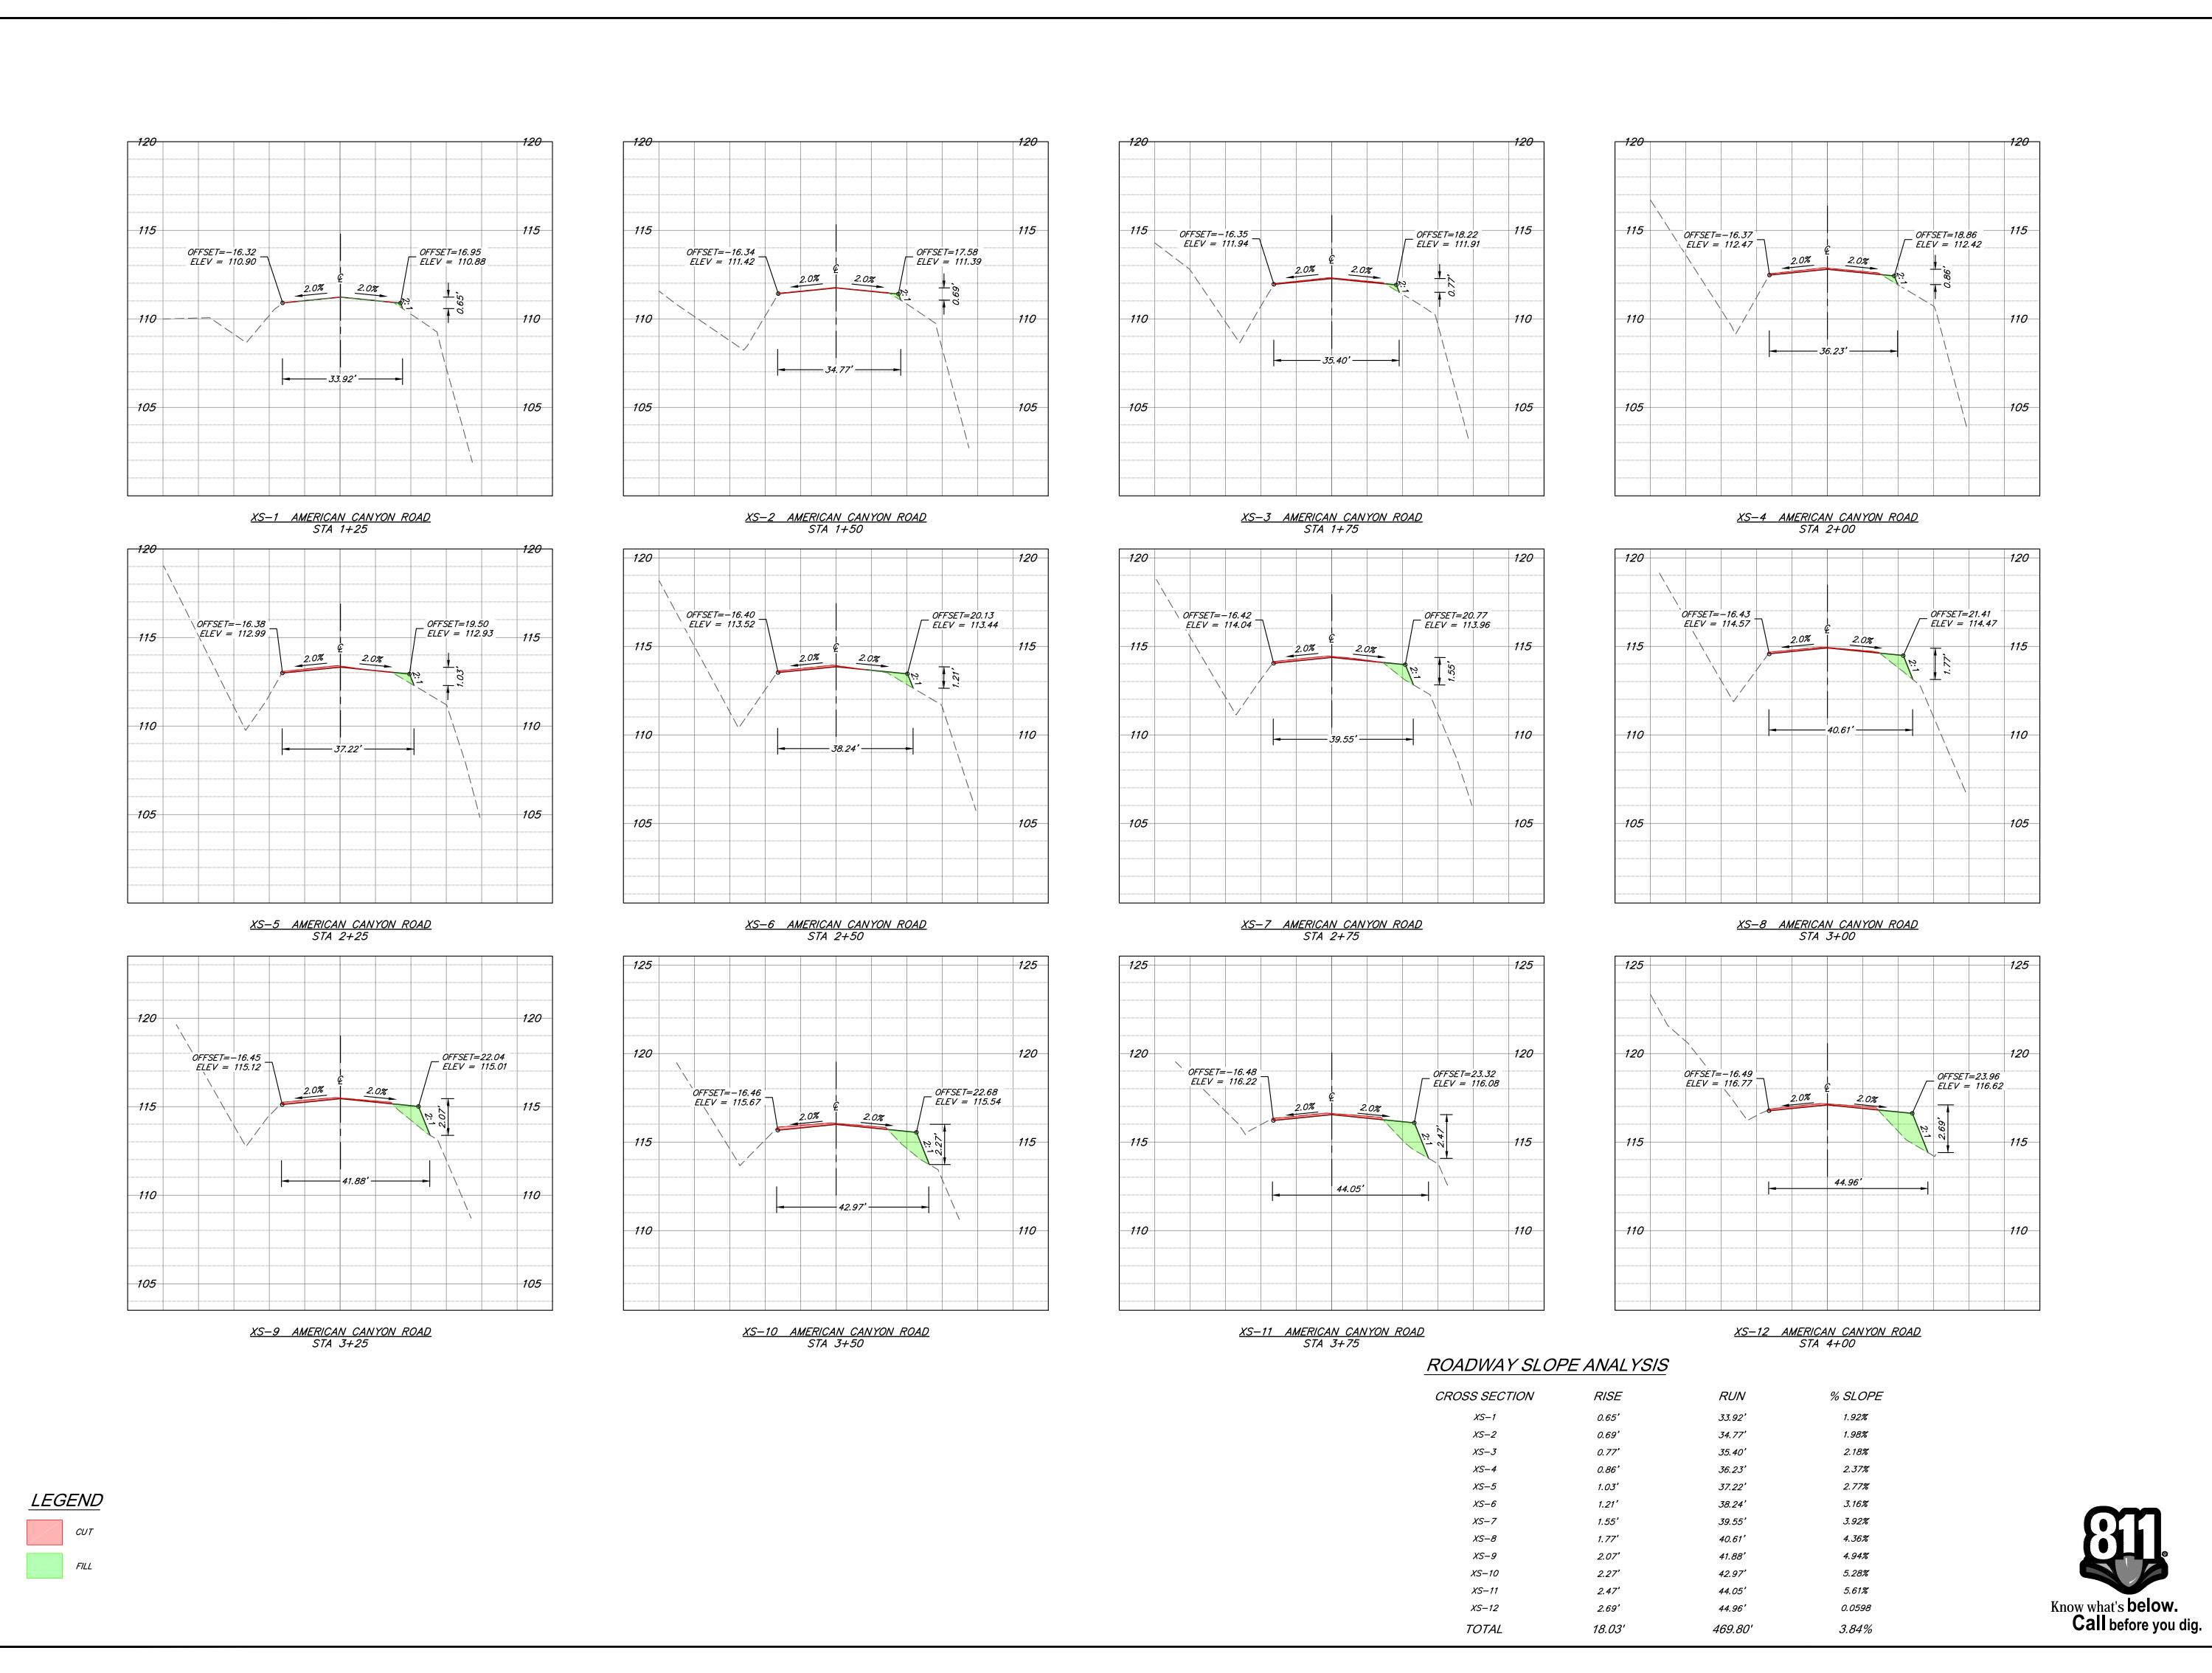



SECTIONS CROSS.

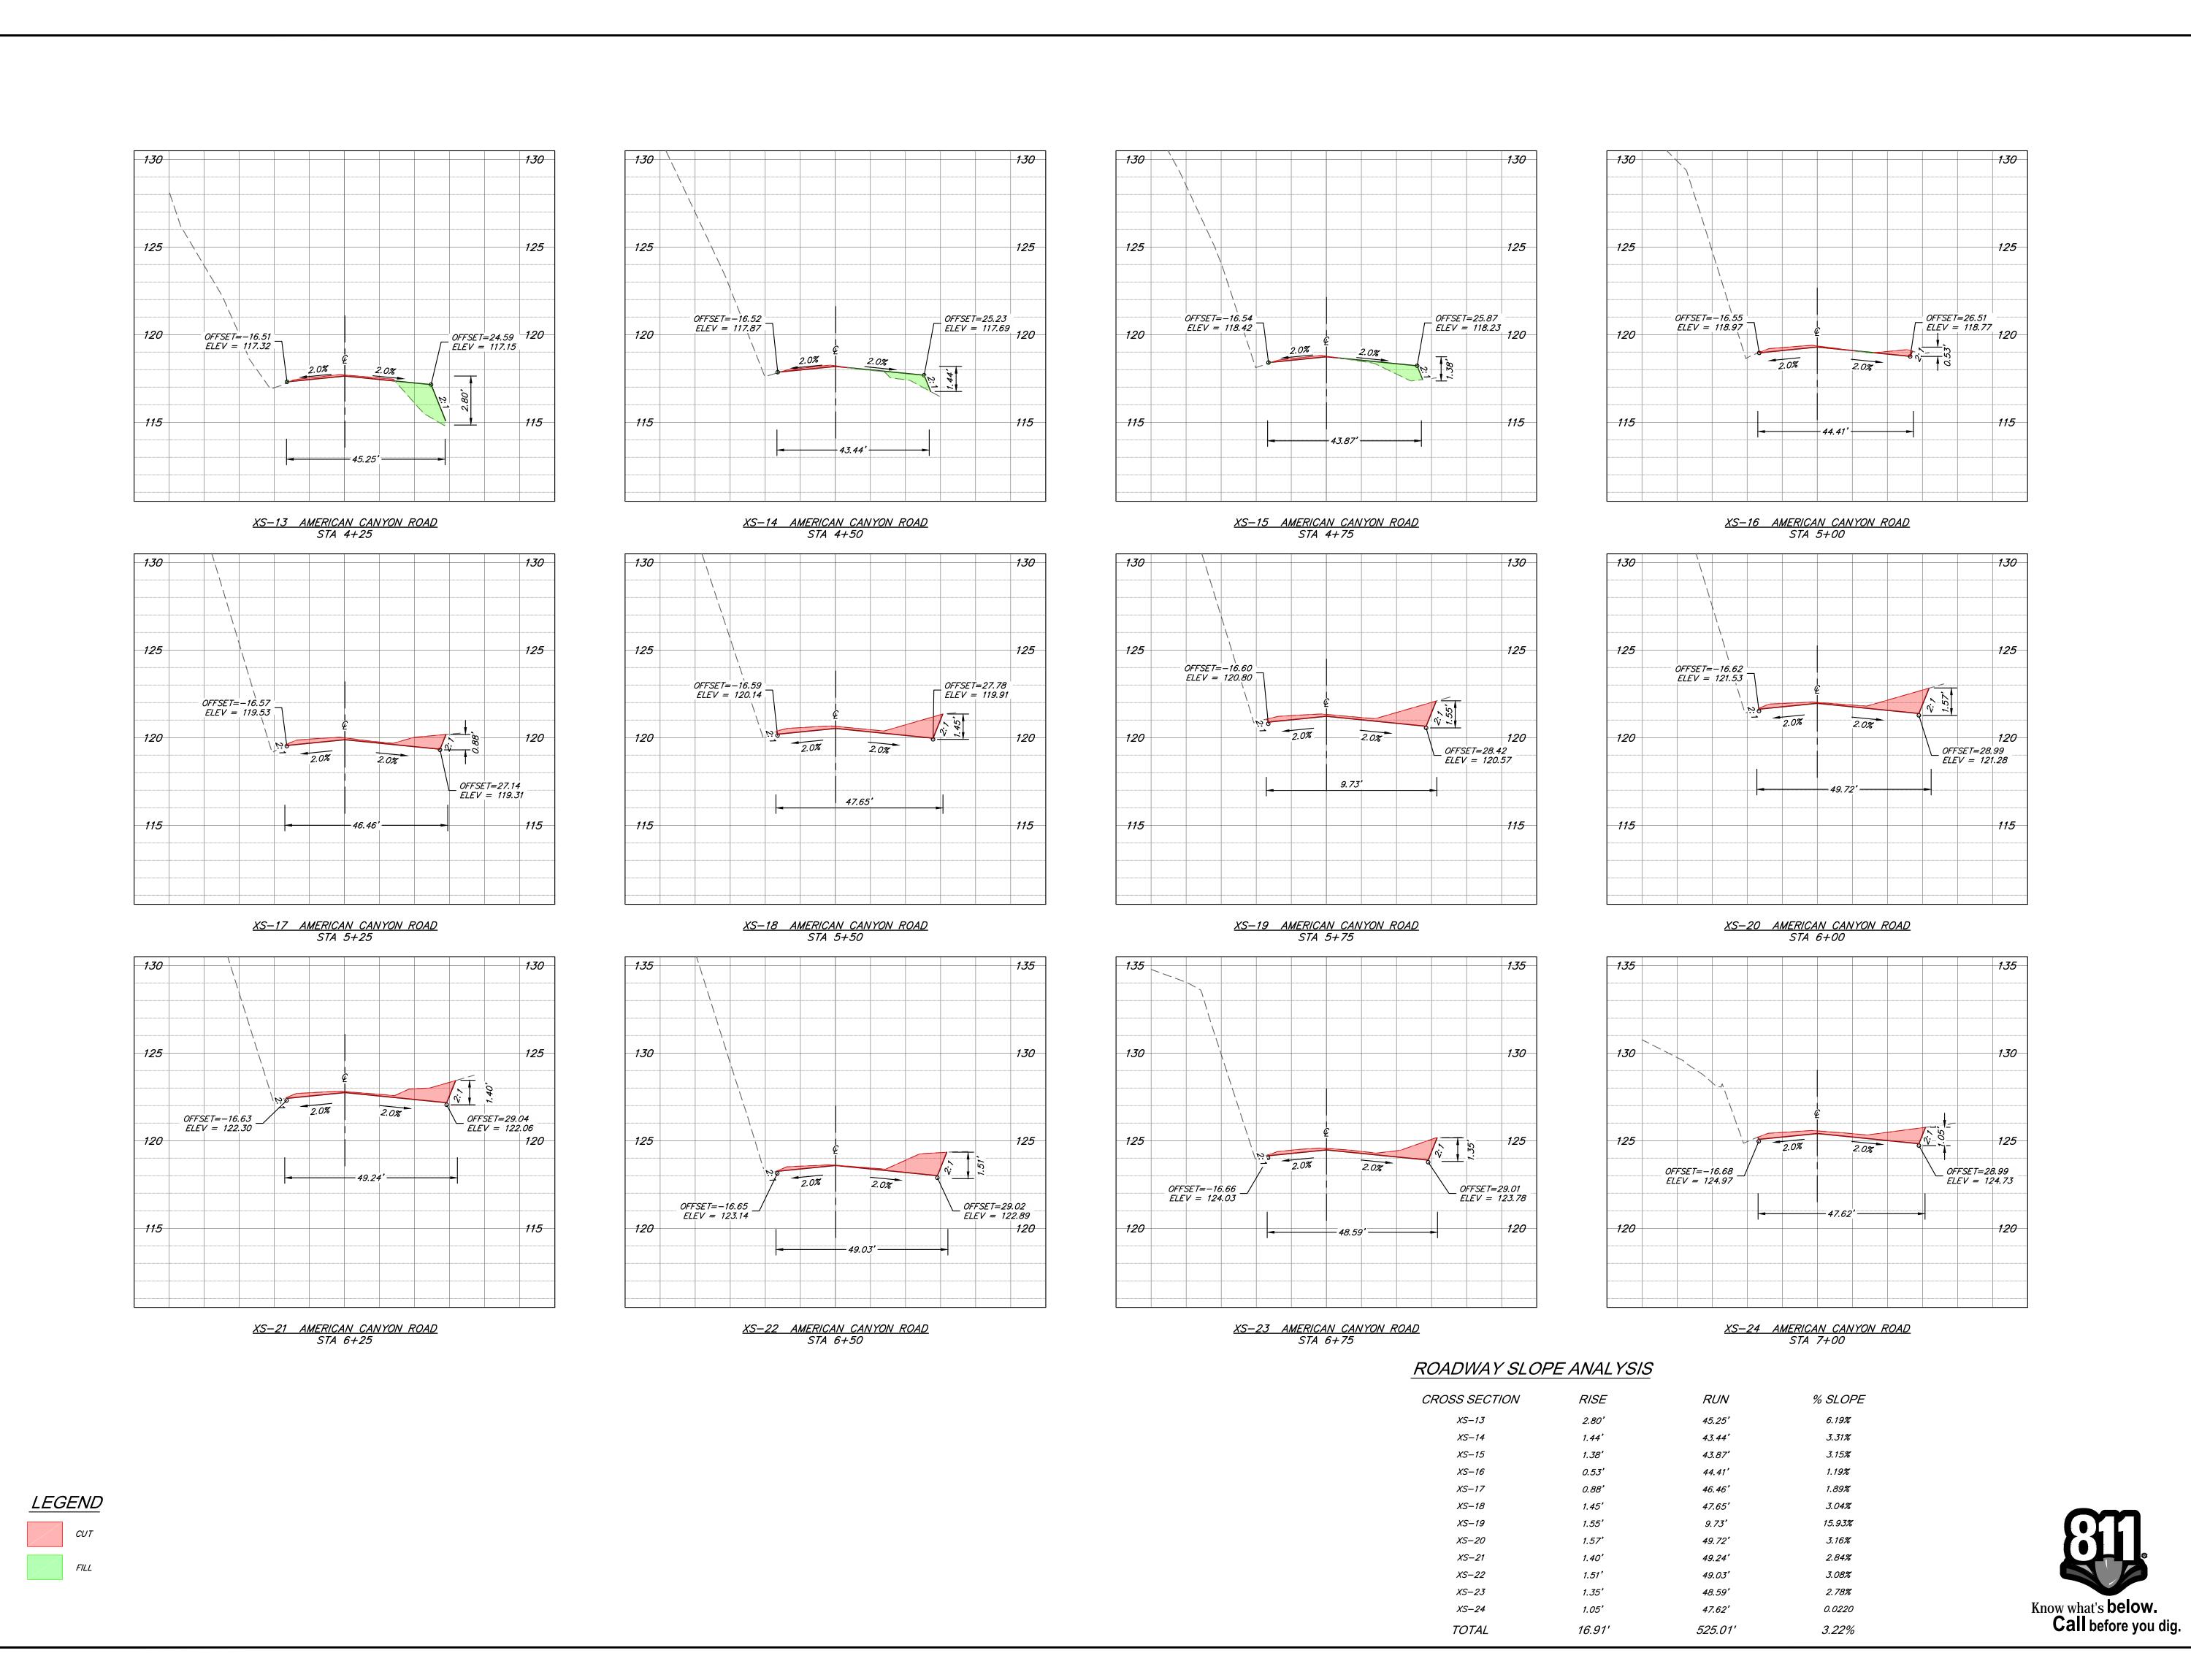

S/GN 94559 No. REVISIONS DA

NORTH BAY
VIL ENGINEERING & DES

* PEGGS ON TO SOLVE T

DATE

MAY 7, 2019

SCALE AS SHOWN

DESIGNED BY EVM


CROSS SECTIONS

VING PLANS


CRC

NEW LIFE COMMUNIT ADVENTIST CHURCH ROADWAY WIDENING PLAN

C7.1

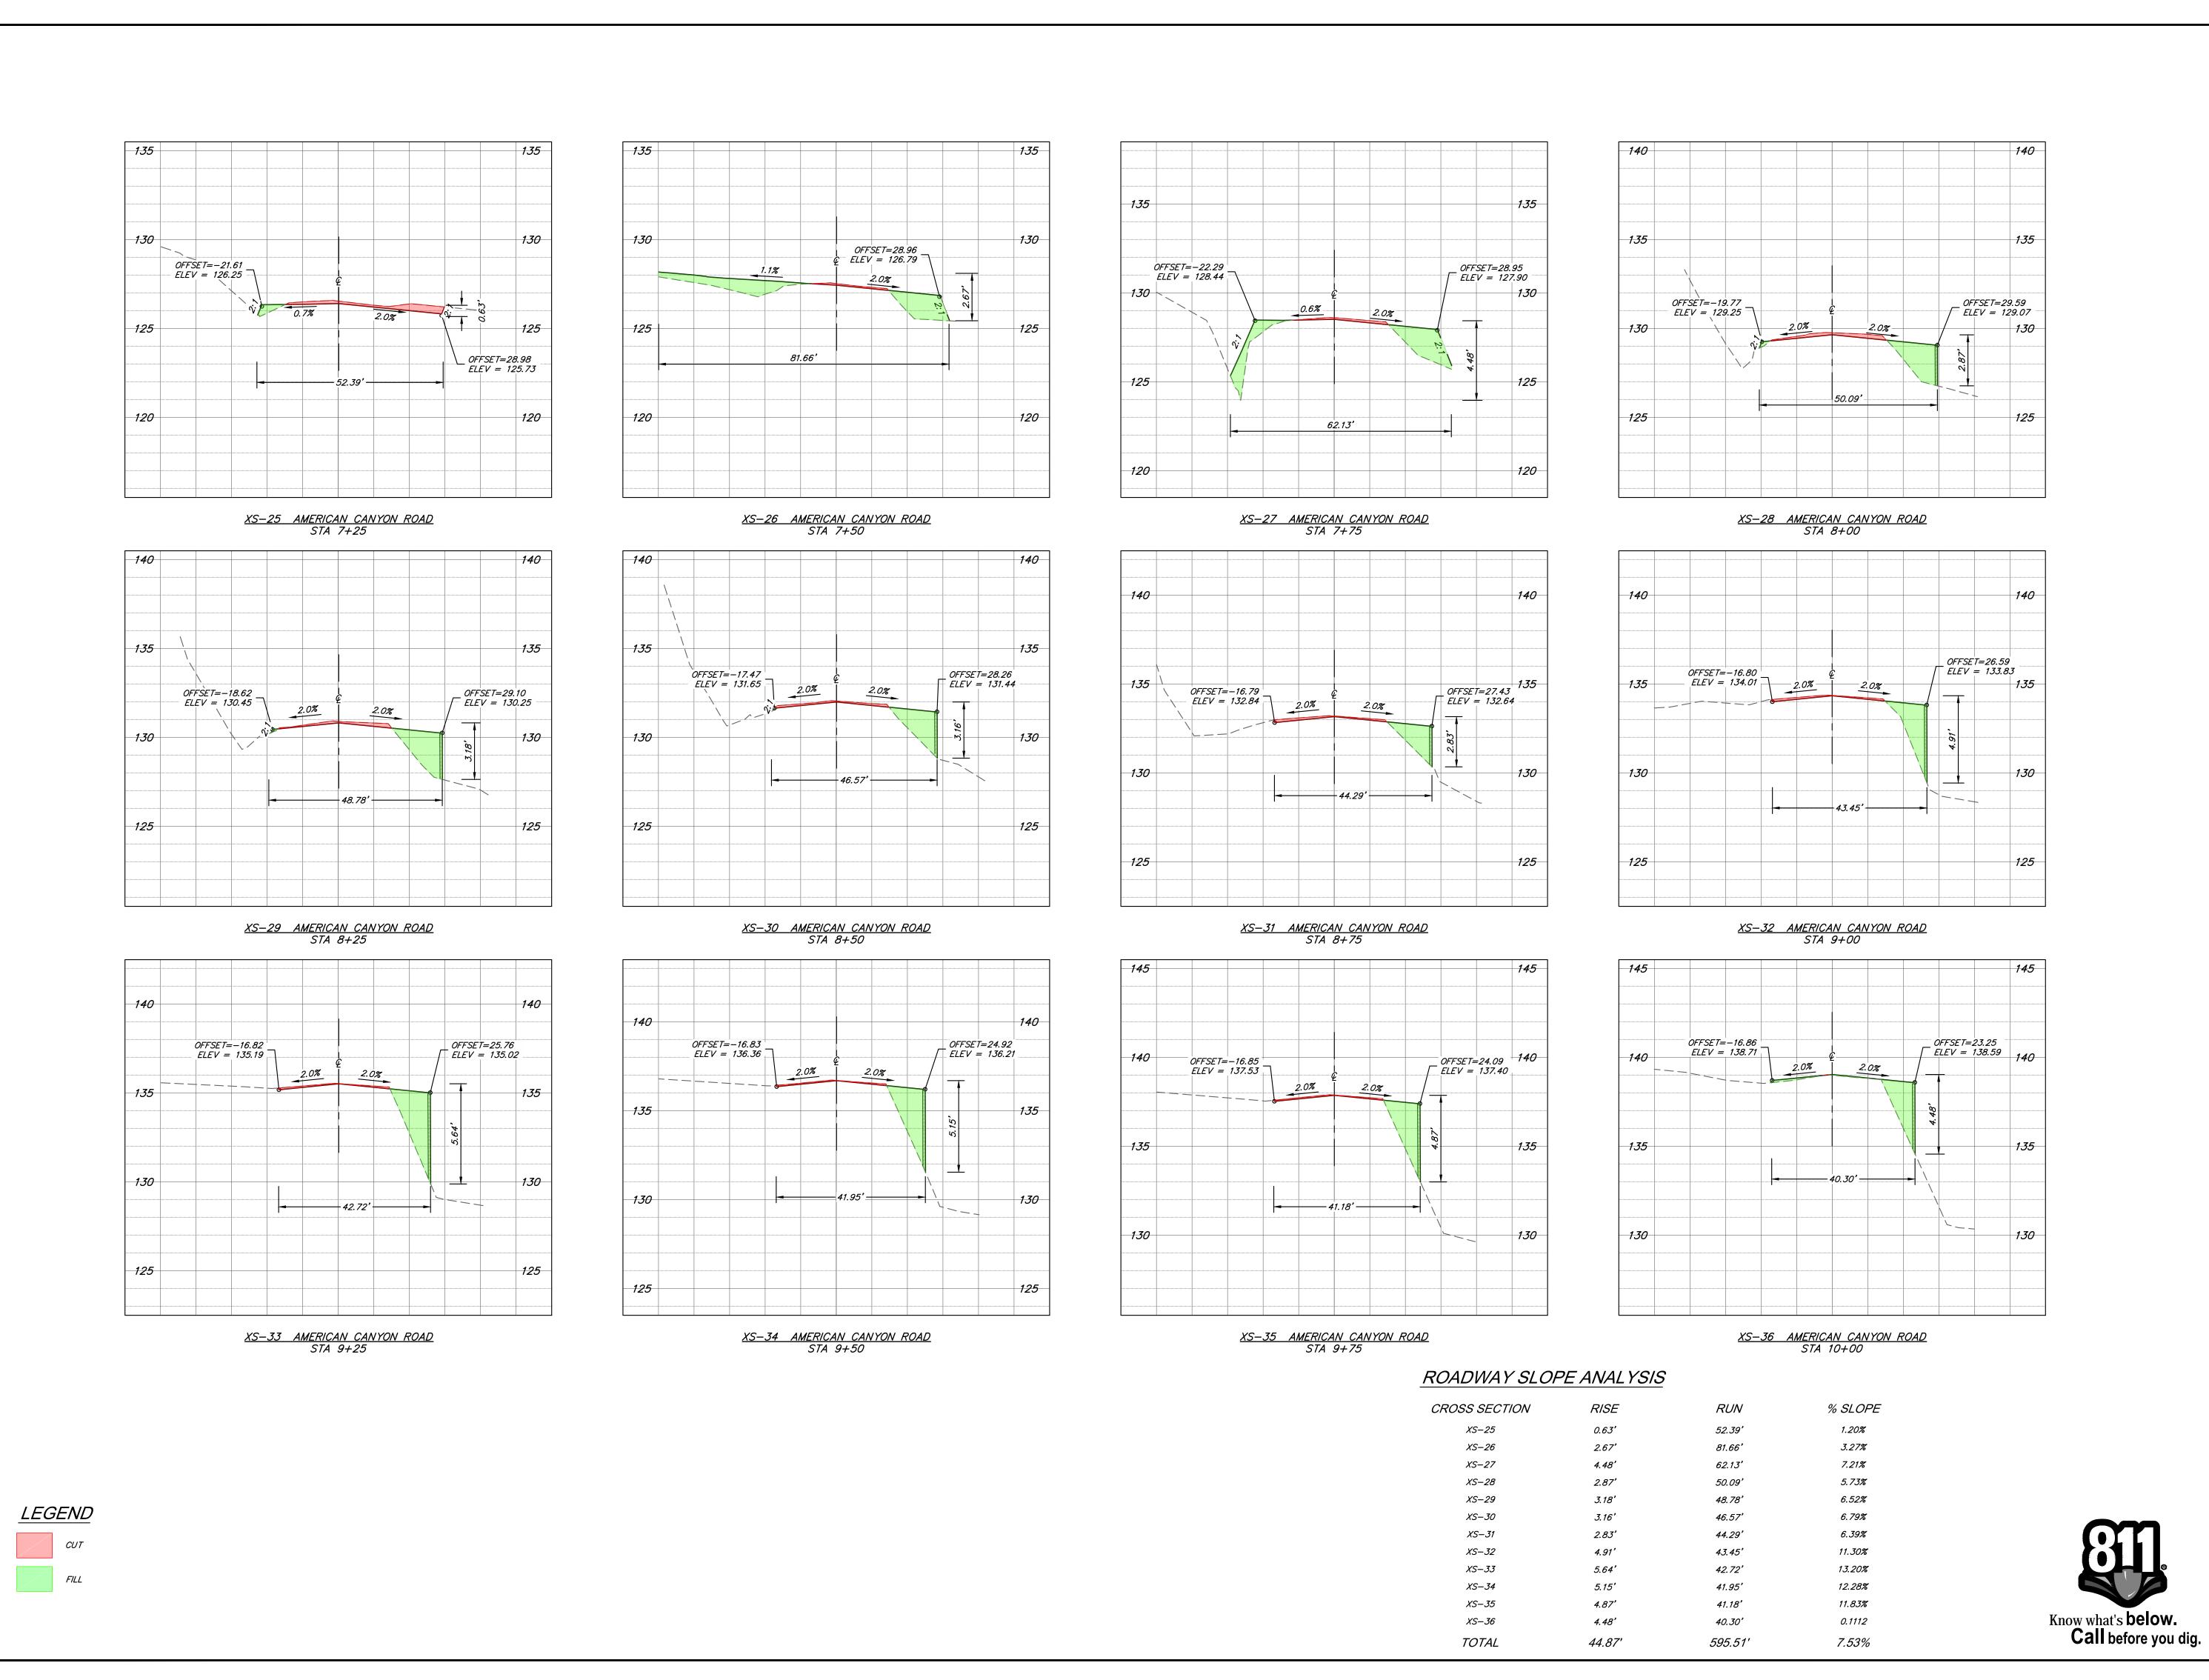

CROSS SECTIONS

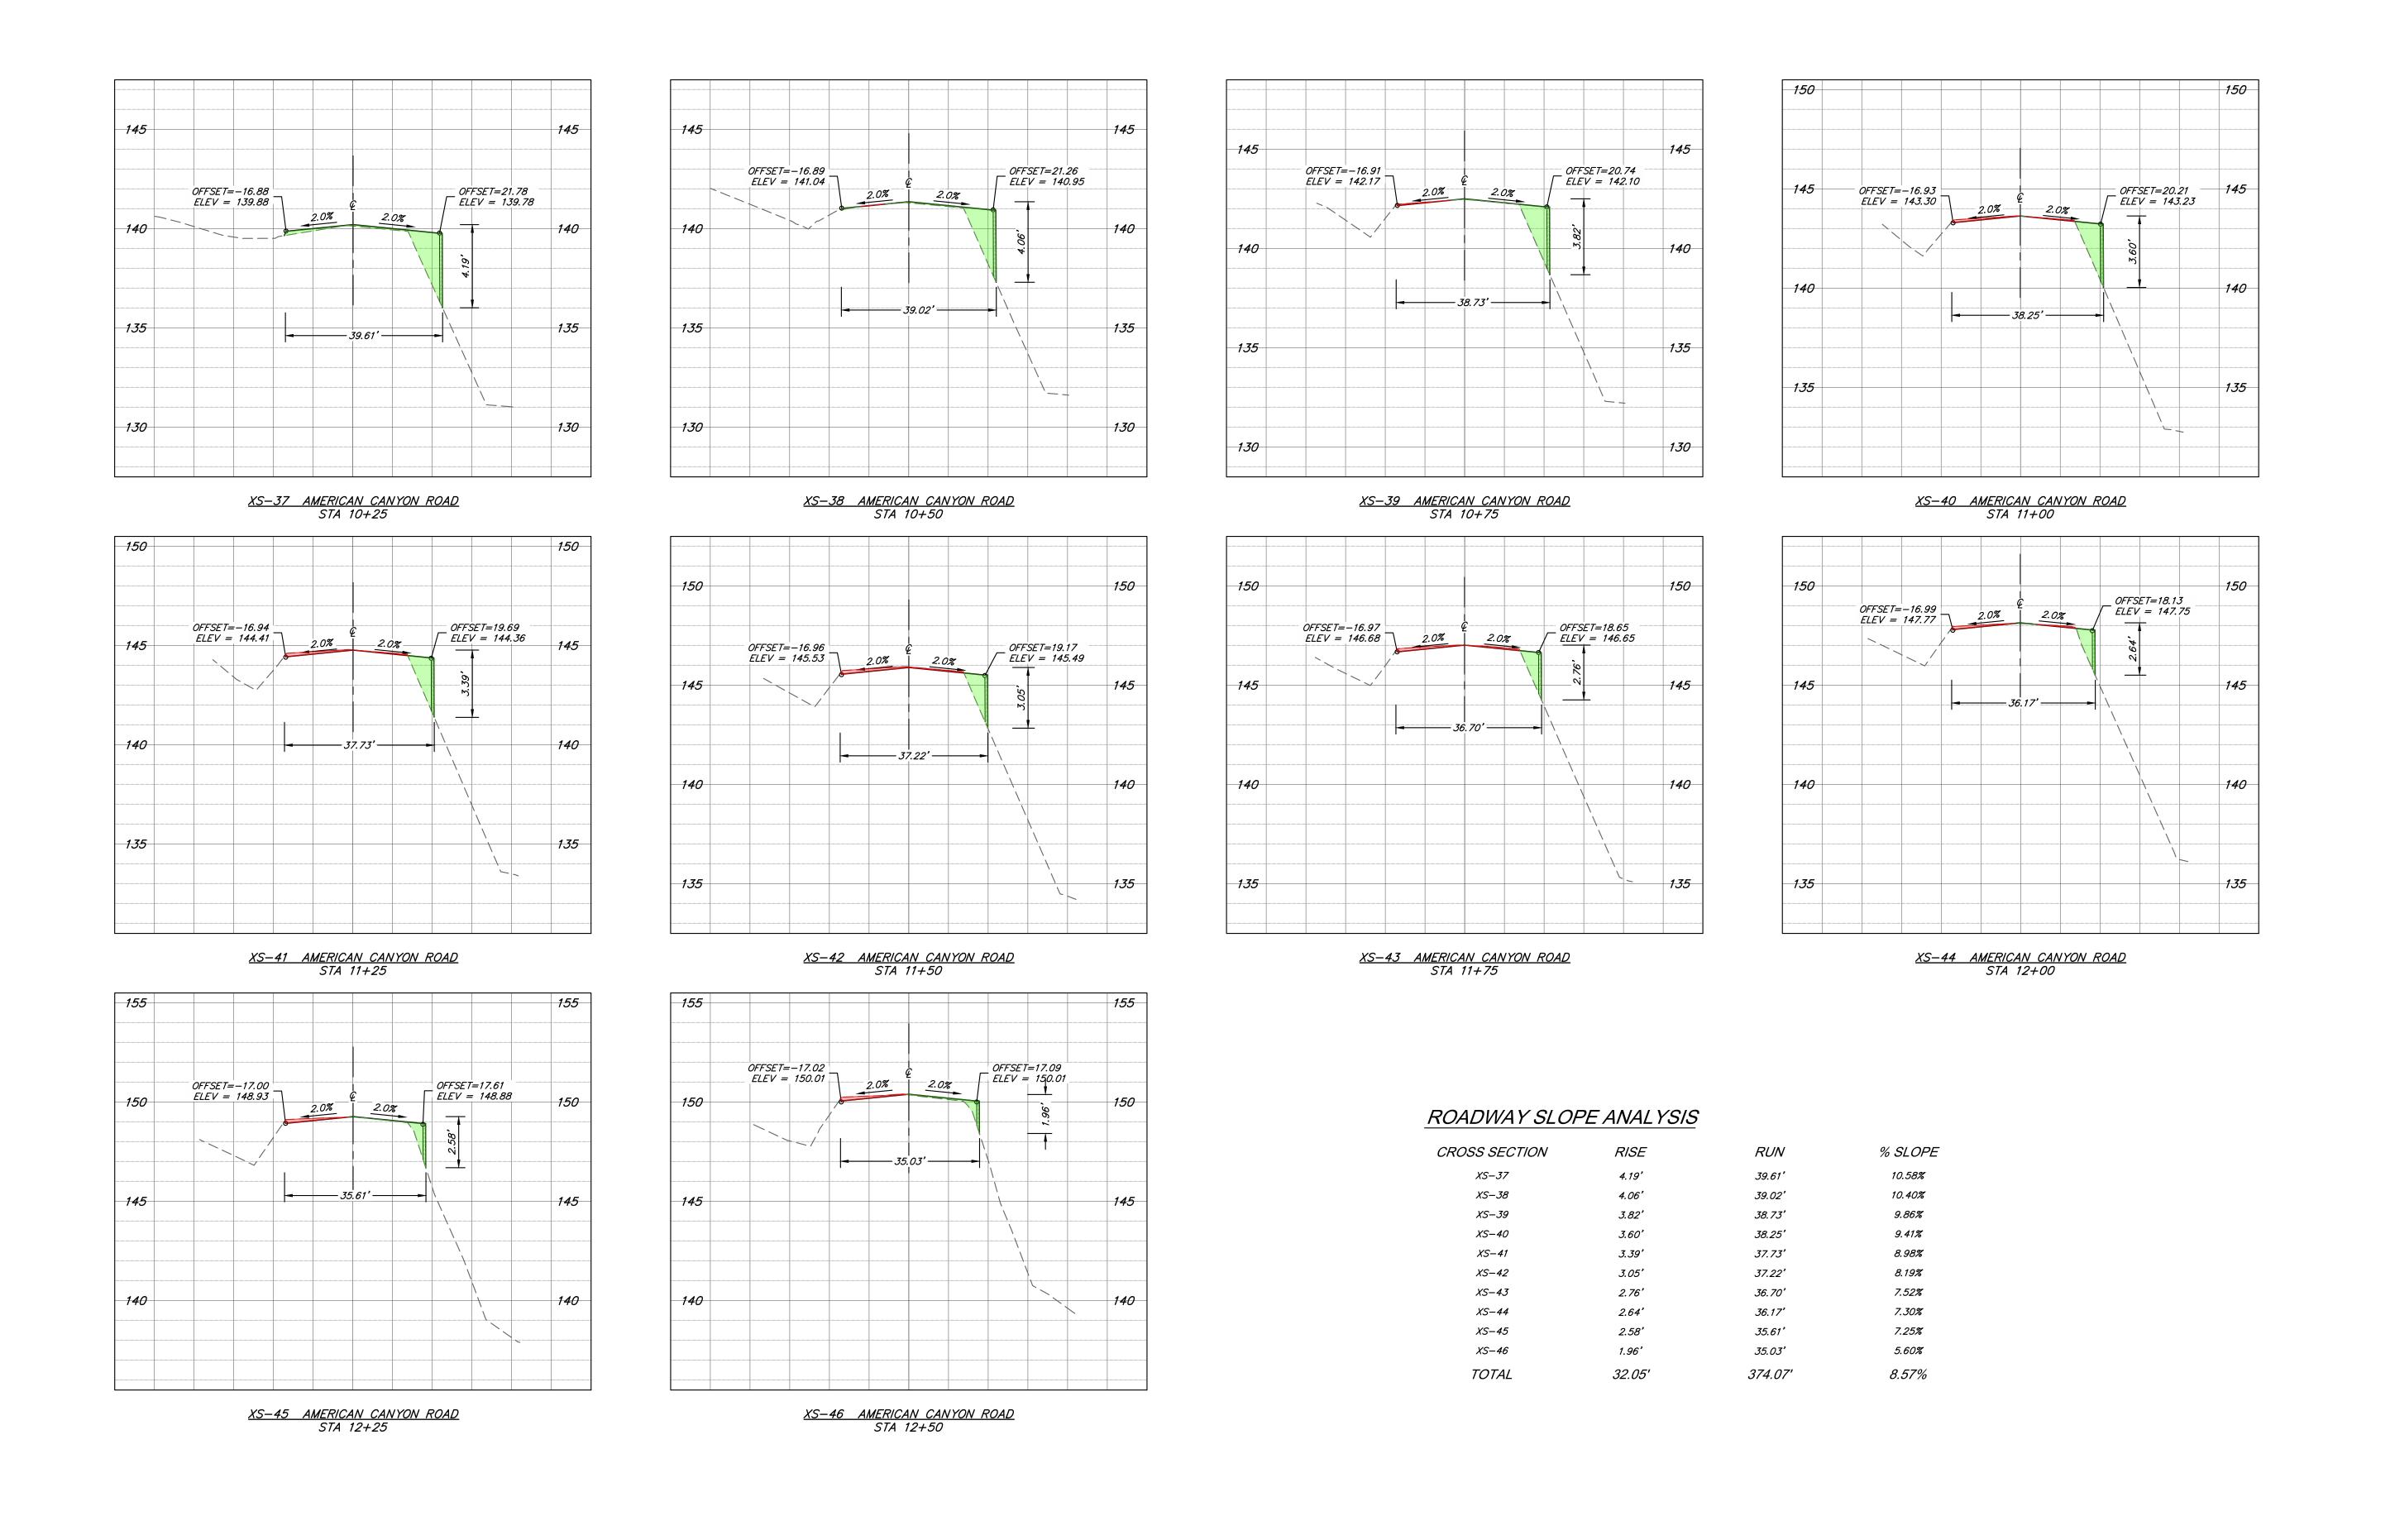

LEGEND


CUT

FILL




C7.3

CROSS SECTIONS

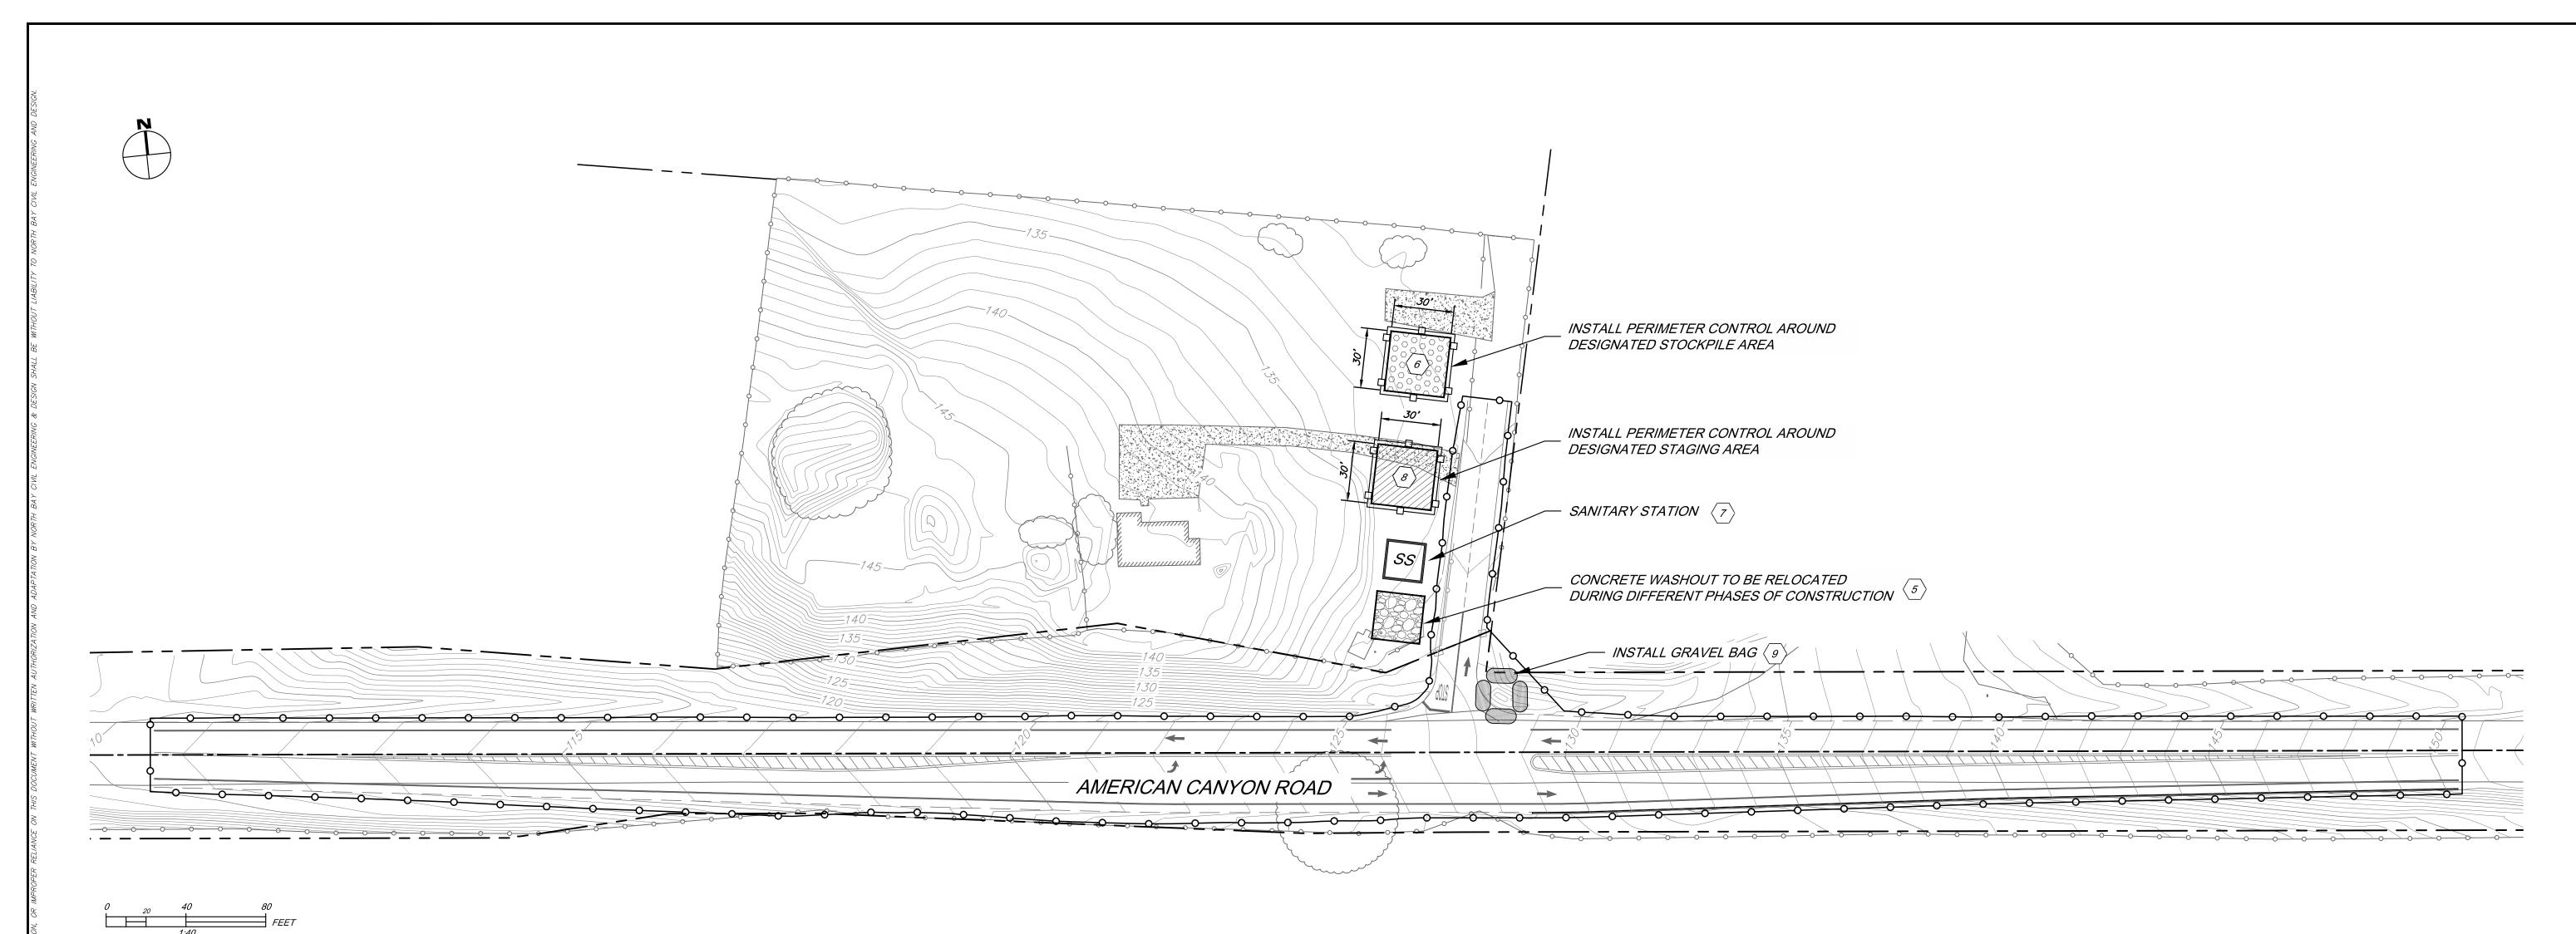

EROSION & SEDIMENT CONTROL LEGEND

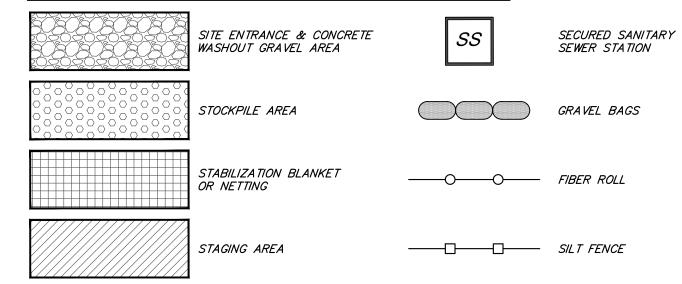

TOTAL DISTRUBED AREA TOTAL PROJECT AREA

TOTAL DISTURBED AREA = 52,840 SF (1.21 AC)

TOTAL PROJECT AREA = 53,084 SF (1.22 AC)

SWPPP NOTES

1) THE PROPOSED PROJECT IS COVERED UNDER THE STATE GENERAL CONSTRUCTION PERMIT. SEE SWPPP

(SWPPP_WDID / SWPPP APP) DATED SWPPP DATE AND PREPARED BY ########## FOR

ALL EROSION, SEDIMENT, AND STORM WATER DISCHARGE CONTROL MEASURES ASSOCIATED WITH THE LAND AND

CONSTRUCTION DISTURBANCE ACTIVITIES FOR THE PROPOSED PROJECT.

EROSION & SEDIMENT CONTROL CONSTRUCTION NOTES

- COVER DISTURBED SOIL WITH STRAW MULCH AND TACKIFIER (OR EQUIVALENT) UNLESS OTHERWISE NOTED.

 AREAS OF DISTURBED SOIL SHALL BE REVEGETATED. EXISTING VEGETATION SHALL BE PRESERVED AS

 MUCH AS PRACTICABLY POSSIBLE. SEE CASQA BMP FACT SHEETS EC-2 & EC-6.
- 2 INSTALL STABILIZED SITE ENTRANCE AND TEMPORARY DRIVEWAY. USE 11/2—INCH CRUSHED DRAIN ROCK FOR 50—FEET (MIN) OR AS FAR AS PRACTICALLY POSSIBLE TO PREVENT TRACKING SOIL OFFSITE.
- 3 INSTALL BIODEGRADABLE FIBER ROLLS ALONG CONTOURS WITH SLOPES OF 3:1 (MAX). KEY FIBER ROLLS 3-INCHES (MIN) INTO THE GROUND. SEE CASQA BMP FACT SHEET SE-5.
- $\langle 4 \rangle$ INSTALL SILT FENCE ALONG CONTOURS WITH SLOPES OF 3:1 (MAX). SEE CASQA BMP FACT SHEET SE-1.
- 5 INSTALL CONCRETE WASHOUT. CLEAN AS NEEDED AND REMOVE AT THE END OF CONSTRUCTION ACTIVITIES. SEE CASQA BMP FACT SHEET WM-8.
- 6 INSTALL STOCKPILE. COVER ALL STOCKPILES AND BERM PROPERLY WITH FIBER ROLLS OR SAND BAGS.

 STOCKPILES SHALL NOT BE LOCATED NEAR BODIES OF WATER. SEE CASQA BMP FACT SHEET WM—3.
- 7 INSTALL SECURED SANITARY SEWER STATION. SANITARY STATION NEAR STABILIZED SITE ENTRANCE,
 AND AWAY FROM GUTTERS, INLETS, AND WATER BODIES. SEE CASQA BMP FACT SHEET WM-9.
- 8 INSTALL STAGING AREA. HAZARDOUS MATERIALS AND REFUSE SHALL NOT BE PLACED DIRECTLY ON SOIL
 AND SHALL BE IN CLOSED CONTAINERS WHICH UTILIZE A SECONDARY CONTAINMENT SYSTEM. PREVENT
 EQUIPMENT FLUID LEAKS ONTO GROUND BY PLACING DRIP PANS OR PLASTIC TARPS UNDER EQUIPMENT.
 SEE CASQA BMP FACT SHEETS WM-6, NS-8, NS-9, AND NS-10.
- INSTALL GRAVEL BAG (OR EQUIVALENT) DRAIN INLET PROTECTION AROUND ON—SITE DRAIN INLETS AND AROUND NEAREST DOWNSTREAM OFF—SITE INLETS. SEE CASQA BMP FACT SHEET SE—10.
- INSTALL STABILIZATION BLANKETS/NETTING (OR EQUIVALENT) IN DISTURBED AREAS WITH SLOPES OF 3:1

 OR STEEPER. KEY STABILIZATION BLANKETS/NETTING 3—INCHES (MIN) INTO THE GROUND. SEE CASQA


 BMP FACT SHEET EC—7.



NORTH BAY

NORTH BAY

CIVIL ENGINEERING & DESIGN STREET NAPA, CA 945

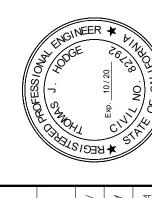

SCALE AS SHOWN

DESIGNED BY EVM

EROSION & SEDIMENT CONTRO

ADWAY WIDENING PLANS

PREPARED FOR

AMERICAN CANYON ROAD

C8.0